

A NEW FACILITY FOR

GREGG COUNTY - PARKING GARAGE & OFFICE

100 E. METHVIN ST. LONGVIEW, TX 75601

SCOPE SET

PROJECT NO.: 20011 DATE: 06/02/2022

CIVIL

BALLARD & BRAUGHTON ENG. 3815 OLD BULLARD ROAD TYLER, TEXAS 75701 903.531.9800 MEP


WALKER CONSULTANTS
2525 BAY AREA BLVD, SUITE 400
HOUSTON, TEXAS 77058
281.280.0068

STRUCTURE

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DEMOLITION PLAN LEGEND:

ARCHITECTS


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EXISTING TREE TO BE REMOVED

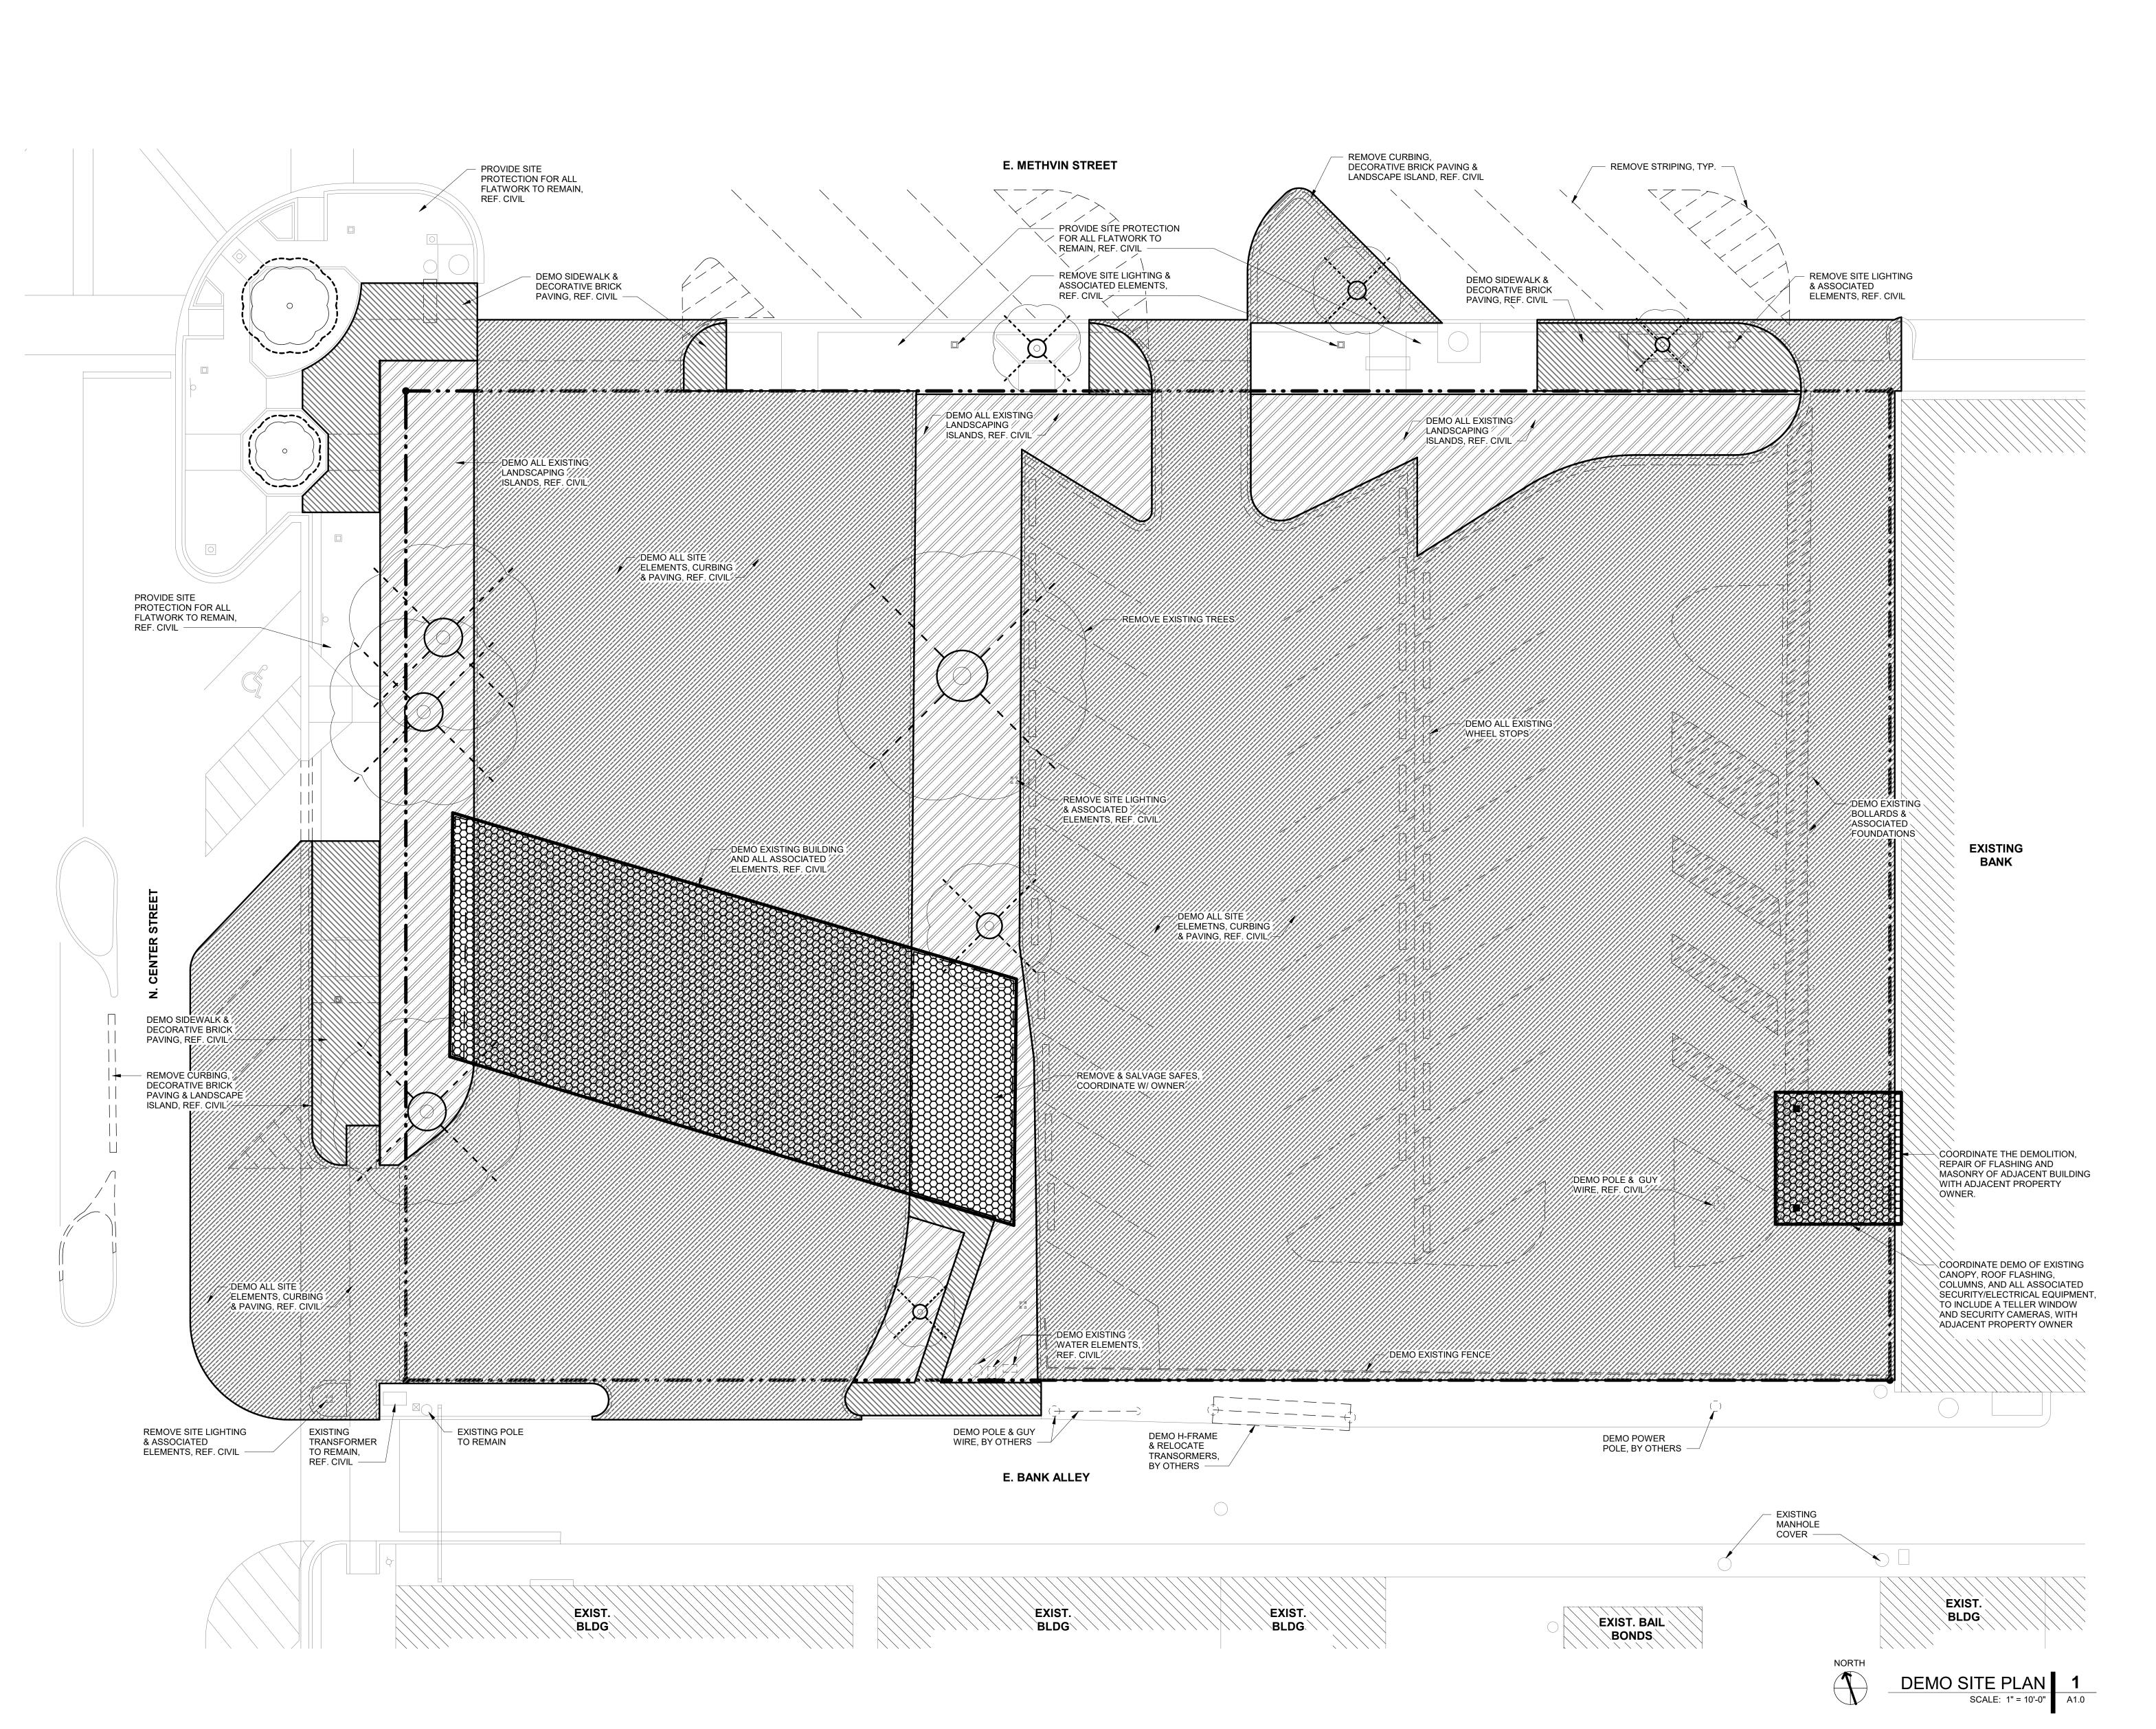




EXISTING SIDEWALK TO

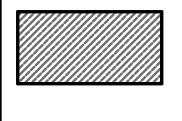

EXISTING PAVEMENT AND CONCRETE CURB TO BE REMOVED

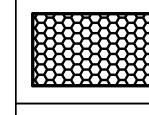

DEMOLISHED.

EXISTING BUILDING TO BE DEMOLISHED

GENERAL DEMOLITION NOTES:

1. CONTRACTOR TO CONDUCT PRE-DEMOLITION MEETING WITH ARCHITECT, AND CITY REPRESENTATIVES PRIOR TO COMMENCEMENT OF DEMOLITION WORK.

2. EXCEPT FOR ITEMS OR MATERIALS INDICATED TO OWNER'S PROPERTY, REMOVE DEMOLISHED

3. DO NOT ALLOW DEMOLISHED MATERIALS TO

4. REMOVE AND TRANSPORT DEBRIS IN A MANNER

5. DO NOT BURN DEMOLISHED MATERIALS ON SITE. 6. SITE AND BUILDING DEMOLITION MAY INCLUDE ITEMS NOT REPRESENTED ON THESE DRAWINGS. CONTRACTOR MUST VERIFY ALL ITEMS TO BE

7. CONTRACTOR TO COVER AND PROTECT EXISTING EXTERIOR FINISHES TO REMAIN ADJACENT TO ITEMS

8. REMOVE DOMESTIC WATER AND SEWER PIPING TO POINT WHERE SERVICE ENTERS THE BUILDING.

10. REMOVE ALL HVAC COMPLETELY, INCLUDING ALL RTU, EXHAUST FANS, DUCTWORK, ETC. 11. REMOVE ALL PHONE/COMM. COMPLETELY BACK TO SERVICE ENTRANCE. VERIFY WITH COMM.

13. REMOVE ALL ROOFING AND FLASHING COMPLETELY, REMOVE ALL ROOF DRAINS AND PIPE BACK TO POINT WHERE DRAINS TIE-IN TO

14. VERIFY WITH THE OWNER IF ANY DEMO ITEM IS

15. CONTRACTOR MUST FILE A NOTIFICATION OF

17. PER TEXAS HISTORIC COMMISSION

18. CONTRACTOR RESPONSIBLE FOR REVIEWING AND COORDINATING ANY DEMOLITION OR NEW WORK WITH SWEPCO IN THE E. BANK ALLEY.

BE RECYCLED, REUSED, SALVAGED, REINSTALLED, OR OTHERWISE INDICATED TO REMAIN THE MATERIALS FROM PROJECT SITE AND LEGALLY DISPOSE OF THEM IN AN APPROVED LANDFILL.

ACCUMULATE ON SITE.

THAT WILL PREVENT SPILLAGE ONTO ADJACENT SURFACES AND AREAS.

TO BE REMOVED.

9. REMOVE ALL ELECTRICAL COMPLETELY, PANELS INCLUDED, BACK TO CONDUIT WHERE SERVICE ENTERS THE BUILDING.

12. REMOVE ALL EXISTING WINDOW COVERINGS COMPLETELY.

UNDERGROUND.

TO BE SALVAGED.

DEMOLITION WITH TCEQ PRIOR TO DEMOLITION. 16. REMOVE AND RECYCLE ALL LAMPS, BALLASTS

AND FREON PRIOR TO DEMOLITION

NOTIFIED.

REQUIREMENTS, CONTRACTOR MUST COORDINATE WITH STONE POINT SERVICES, CONTACT TODD MCMAKIN (todd@stonepointservices.com 903-881-3103) PRIOR TO DEMOLITION FOR MONITORING DURING PAVEMENT REMOVAL. FURTHERMORE, IF DURING DEEPER EXCAVATION A HISTORIC FEATURE IS IDENTIFIED, WORK SHALL STOP AND THE "THC"

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COUNTRAGE

TOD HANSON REG.# 14934


REVISION SCHEDULE

PROJECT NO.: 20011 DATE: 06/02/2022

_TIER 2

DEMOLITION SITE PLAN

SHEET NAME

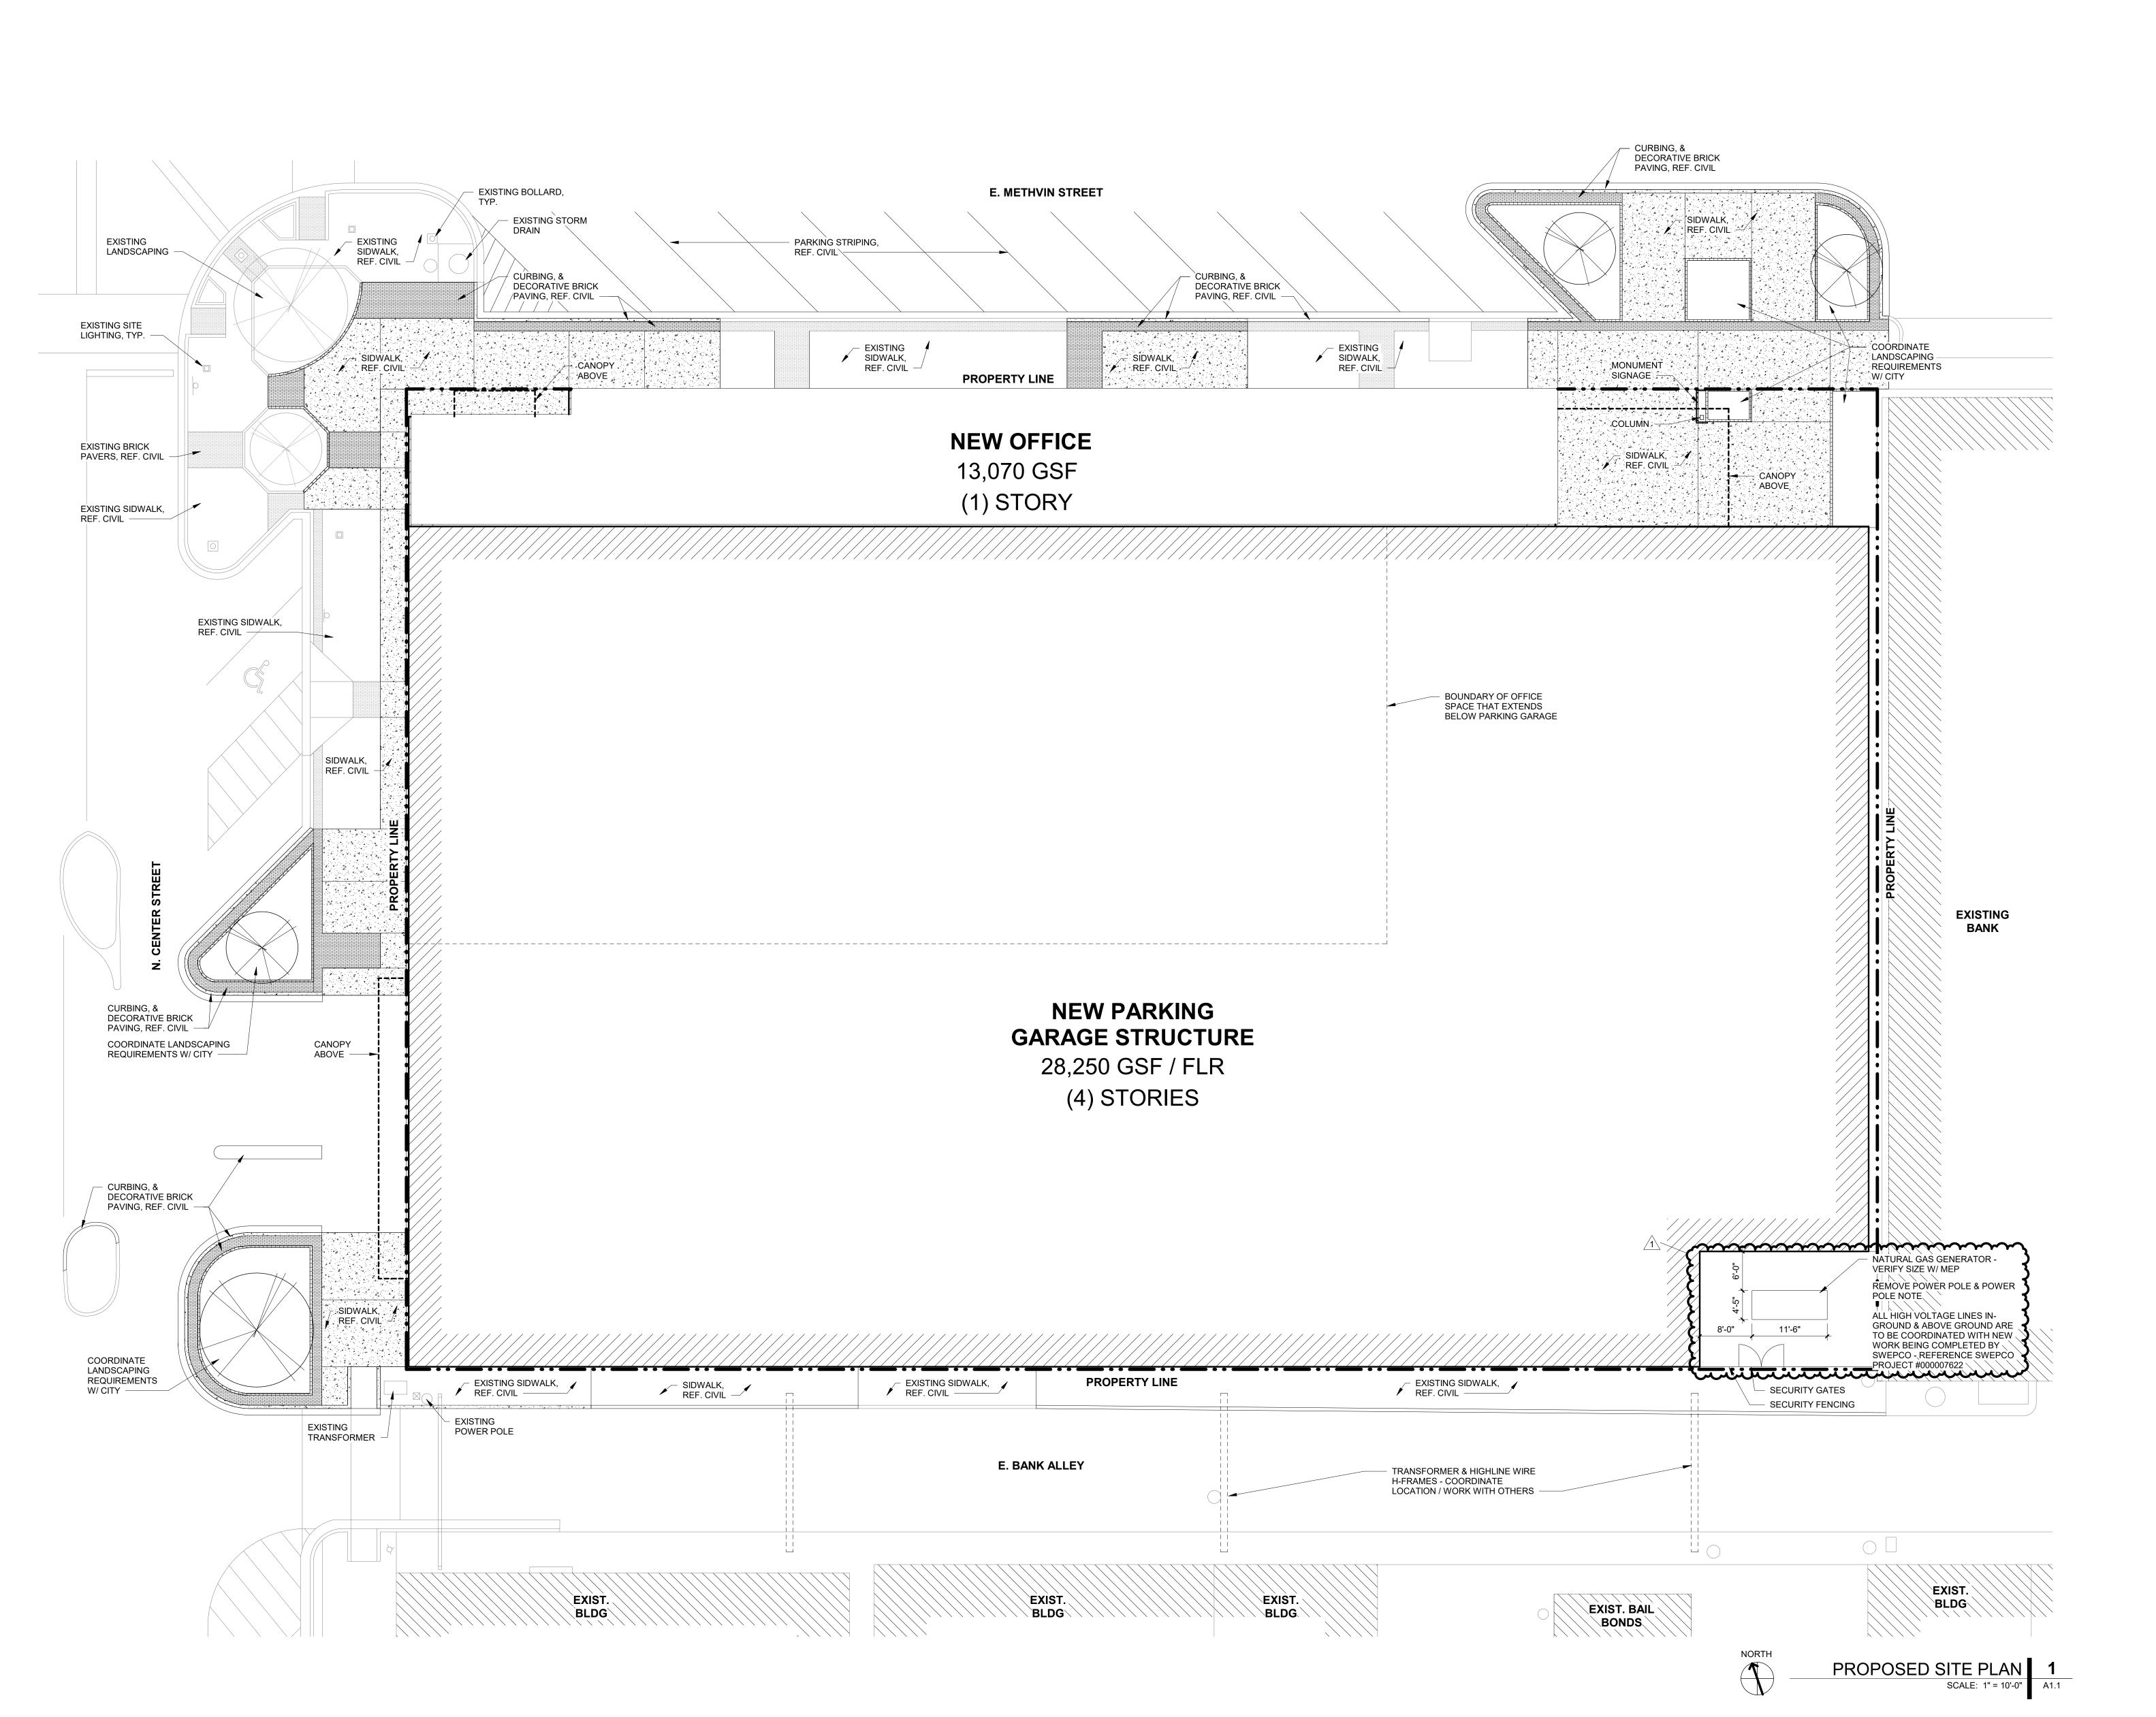

GENERAL NOTES:

1. THE CITY OF 'X' CONSTRUCTION STANDARDS APPLY, WHETHER INDICATED ON THESE PLANS OR

2. CONTRACTOR SHALL BE RESPONSIBLE FOR PRODUCING ANY REQUIRED TRENCH SAFETY PLAN OR TRAFFIC CONTROL PLAN.

3. PRIOR TO STARTING CONSTRUCTION, THE CONTRACTOR SHALL MAKE CERTAIN THAT ALL REQUIRED PERMITS AND APPROVALS HAVE BEEN

OBTAINED. 4. EROSION CONTROLS SHALL BE IN PLACE PRIOR TO THE DISTURBANCE OF ANY EXISTING SURFACE. 5. IT IS THE RESPONSIBILITY OF THE CONTRACTOR TO PROTECT ALL PUBLIC UTILITIES IN THE CONSTRUCTION OF THIS PROJECT. ALL MANHOLES, CLEANOUTS, VALVE BOXES, FIRE HYDRANTS, ETC. MUST BE ADJUSTED TO PROPER LINE AND GRADE BY THE CONTRACTOR PRIOR TO AND AFTER THE PLACING OF PERMANENT PAVING. UTILITIES MUST BE MAINTAINED TO PROPER LINE AND GRADE DURING CONSTRUCTION OF THIS PROJECT.

6. ALL UNDERGROUND UTILITIES AND SLEEVES (IRRIGATION AND SITE LIGHTING) MUST BE INSTALLED BEFORE PAVING.

7. ALL PAVEMENT REPAIR WORK REQUIRES FULL PANEL REPLACEMENT.

8. ALL RETAINING/DETAINING WALLS, TURN-DOWN CURBS, TREE RETAINING WALLS SHALL BE CLAD IN A MATERIAL TO COMPLEMENT THE MATERIALS AND COLORS WITHIN THIS DEVELOPMENT.

9. ALL GROUND BASED HVAC SHALL BE SCREENED WITH LIVE SCREENING OR MASONRY ENCLOSURE. MASONRY ENCLOSURE SHALL BE CLAD IN THE SAME MATERIAL AS THE MAIN BUILDING.

10. ALL ROOF-MOUNTED MECHANICAL UNITS AND/OR EQUIPMENT SHALL BE SCREENED FROM

11. DUMPSTER SCREENING WALL SHALL BE CLAD IN A MATERIAL TO MATCH THE MATERIALS ON THE MAIN BUILDING.

12. DUMPSTER SCREENING WALL REQUIRES A SEPARATE BUILDING PERMIT.

13. SIGNS REQUIRE A SEPARATE BUILDING PERMIT. ANY SIGNS DEPICTED ON THE SUBJECT SITE PLAN/ELEVATIONS ARE NOT APPROVED AS A PART OF THIS REVIEW AND MUST COMPLY WITH ALL APPLICABLE TOWN REGULATIONS.

14. REFERENCE CIVIL, LANDSCAPE, AND ELECTRICAL DRAWINGS FOR ADDITIONAL INFORMATION.

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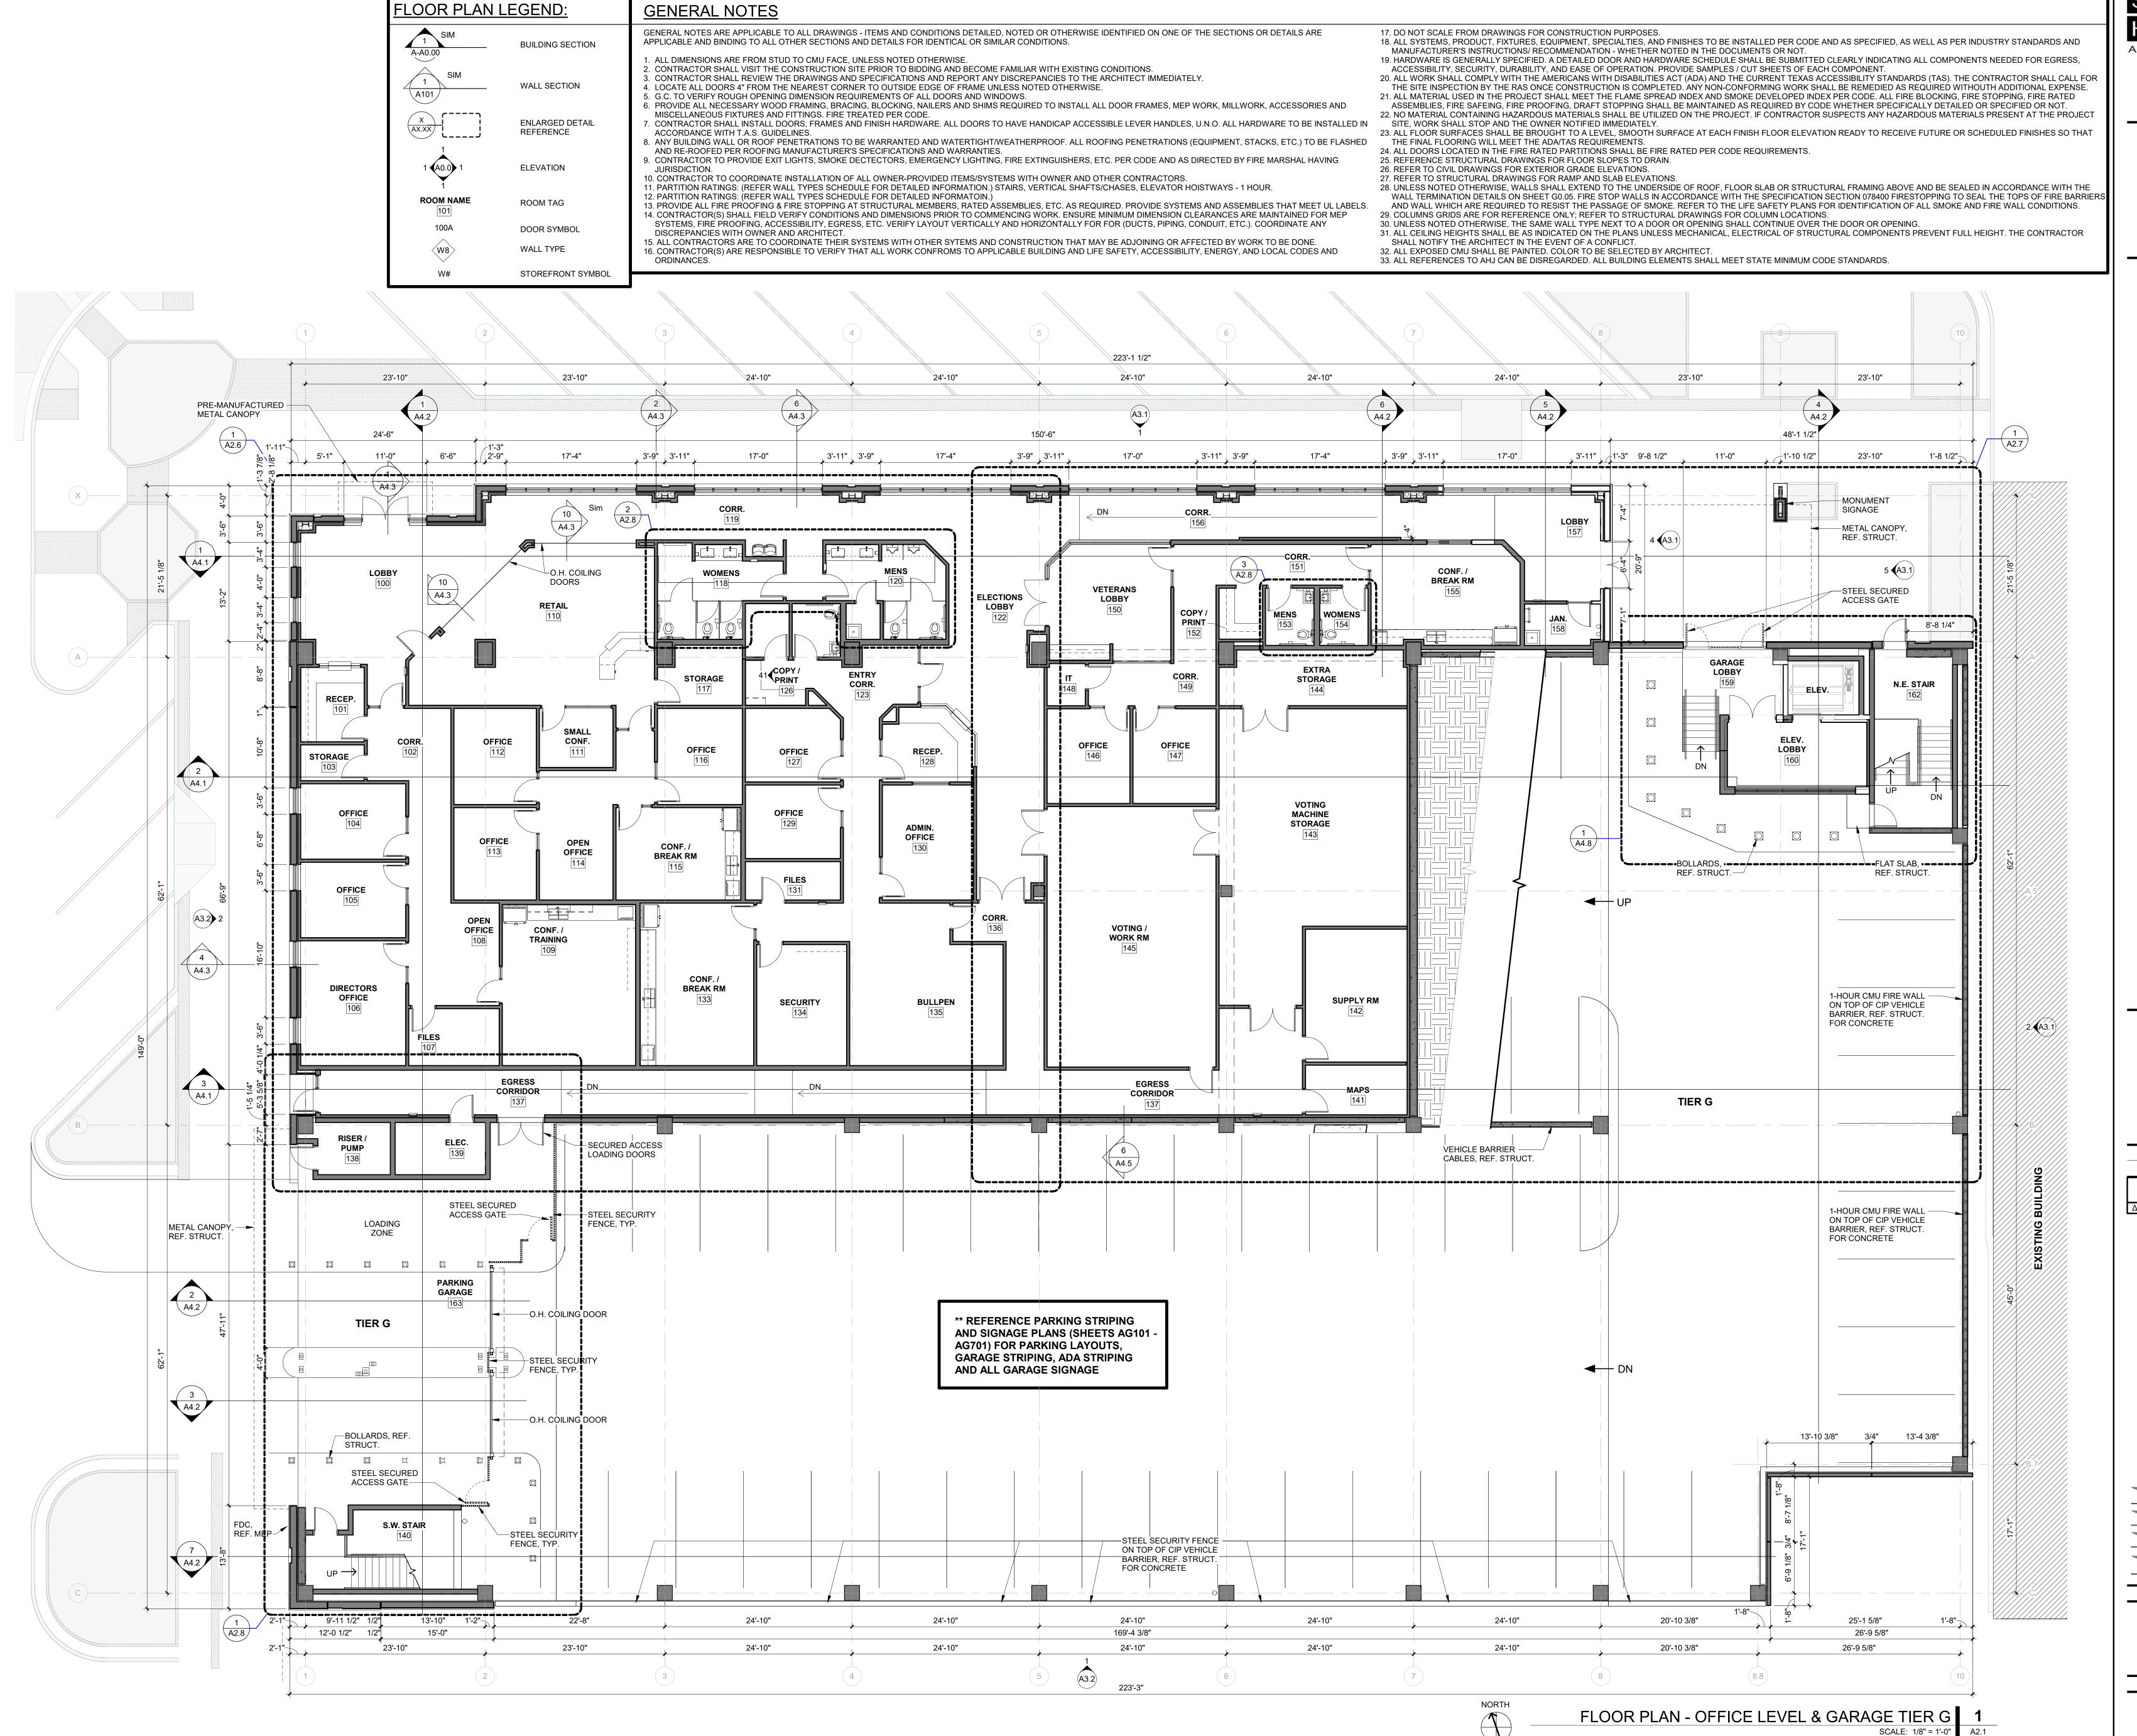
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PROJECT NO.: 20011 DATE: 06/02/2022

REVISION SCHEDULE Δ Description1 ADDENDUM 04

> TIER 2 SHEET NAME

ARCHITECTURAL SITE



ARCHITECTS

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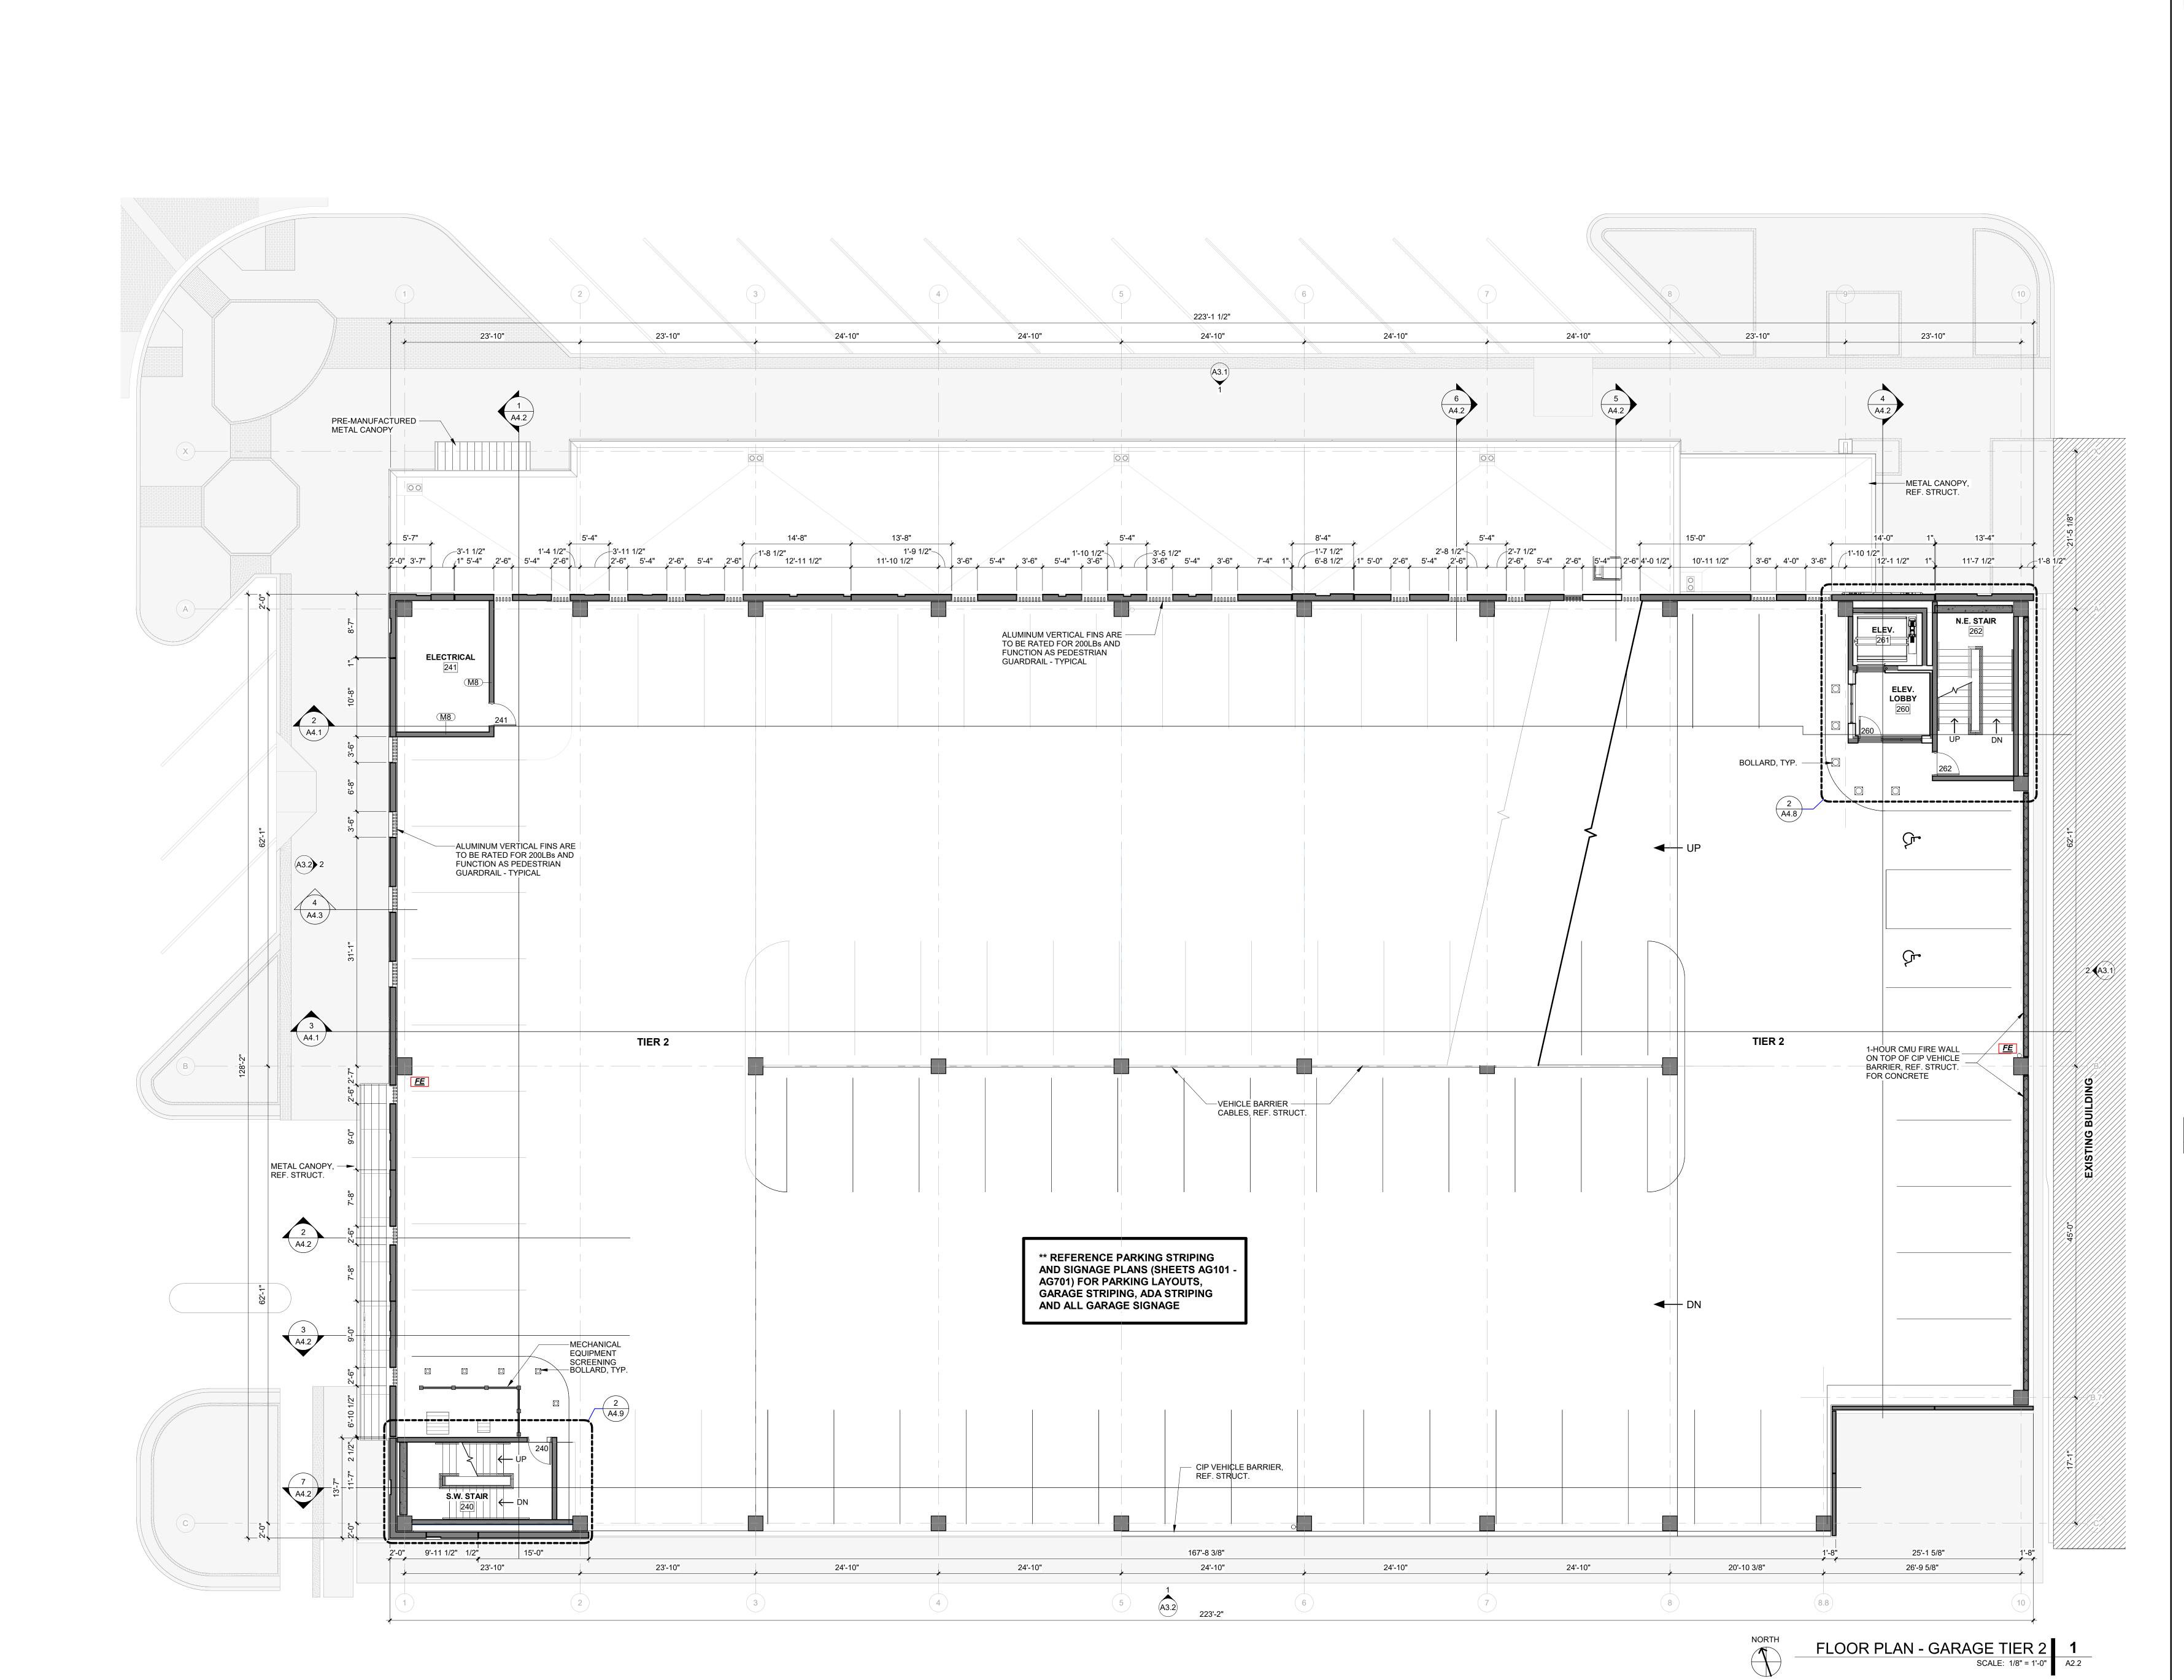
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REG.# 14934

PROJECT NO.: 20011 DATE: 06/02/2022 **REVISION SCHEDULE**

TIER 2 OFFICE/TIER G SHEET NAME

FLOOR PLAN - OFFICE LEVEL & GARAGE TIER G



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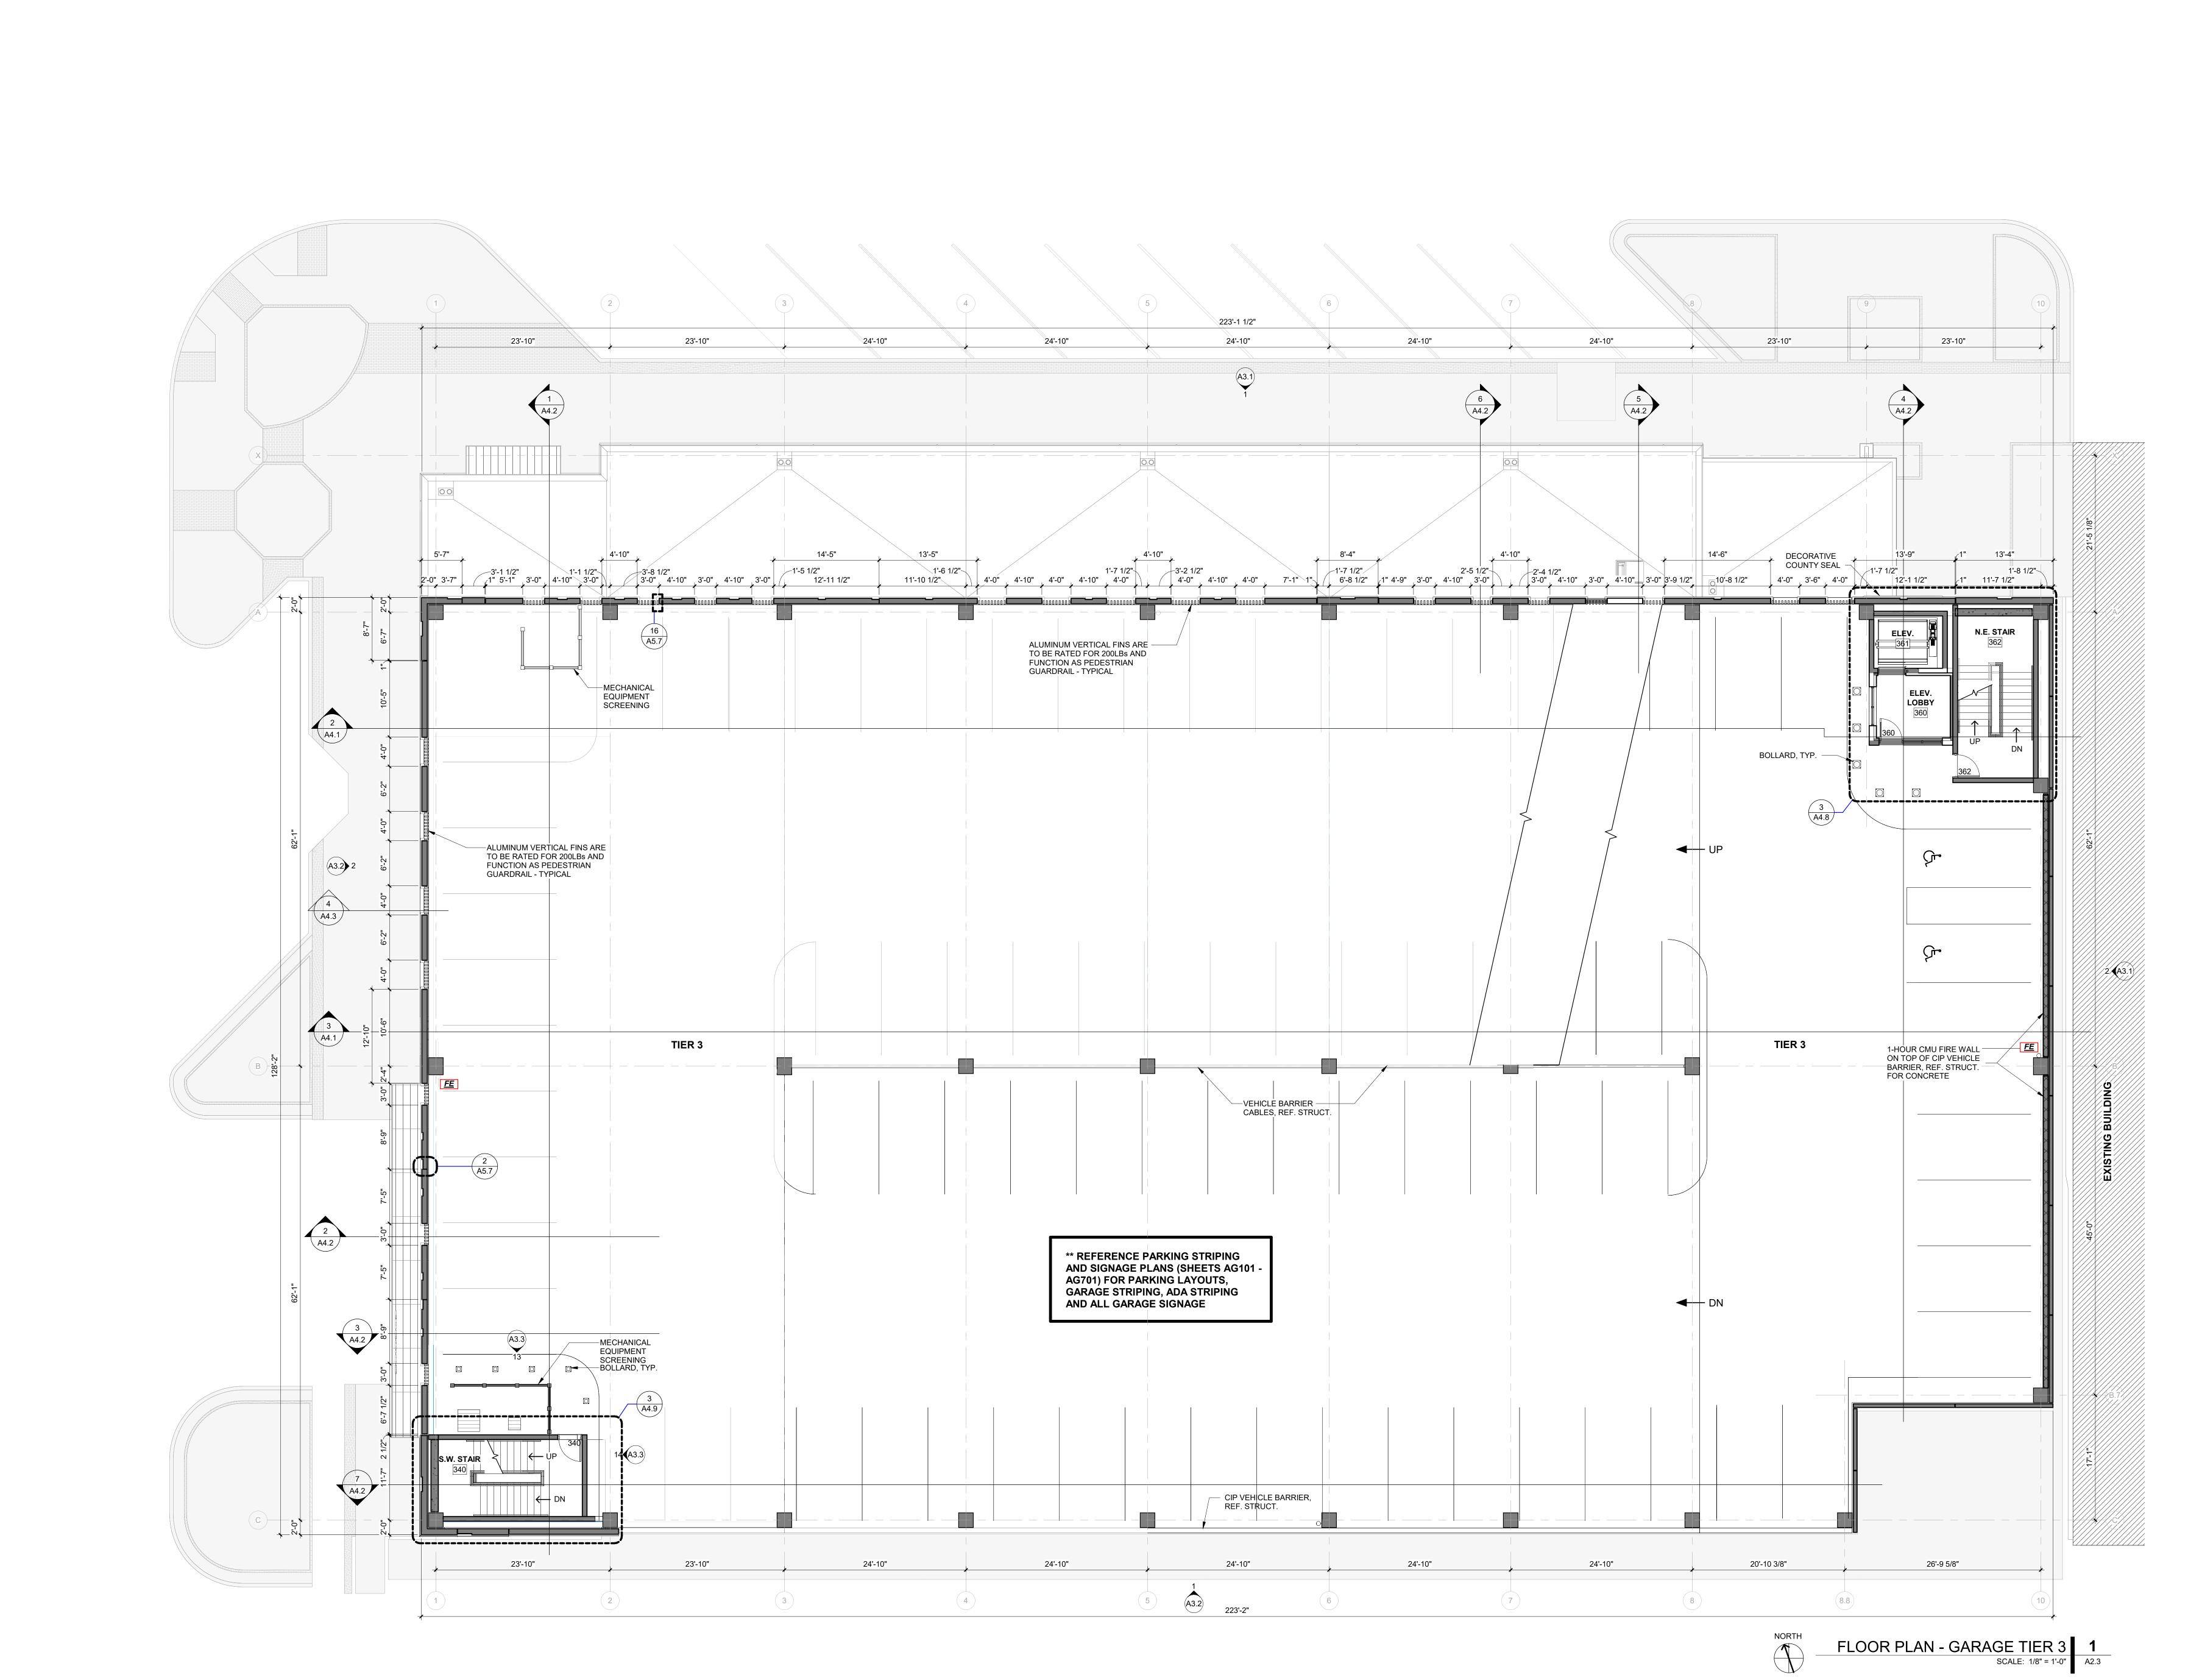
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PROJECT NO.: 20011

DATE: 06/02/2022 **REVISION SCHEDULE**

TIER 3 _TIER 2 OFFICE/TIER G SHEET NAME

FLOOR PLAN - GARAGE TIER 2



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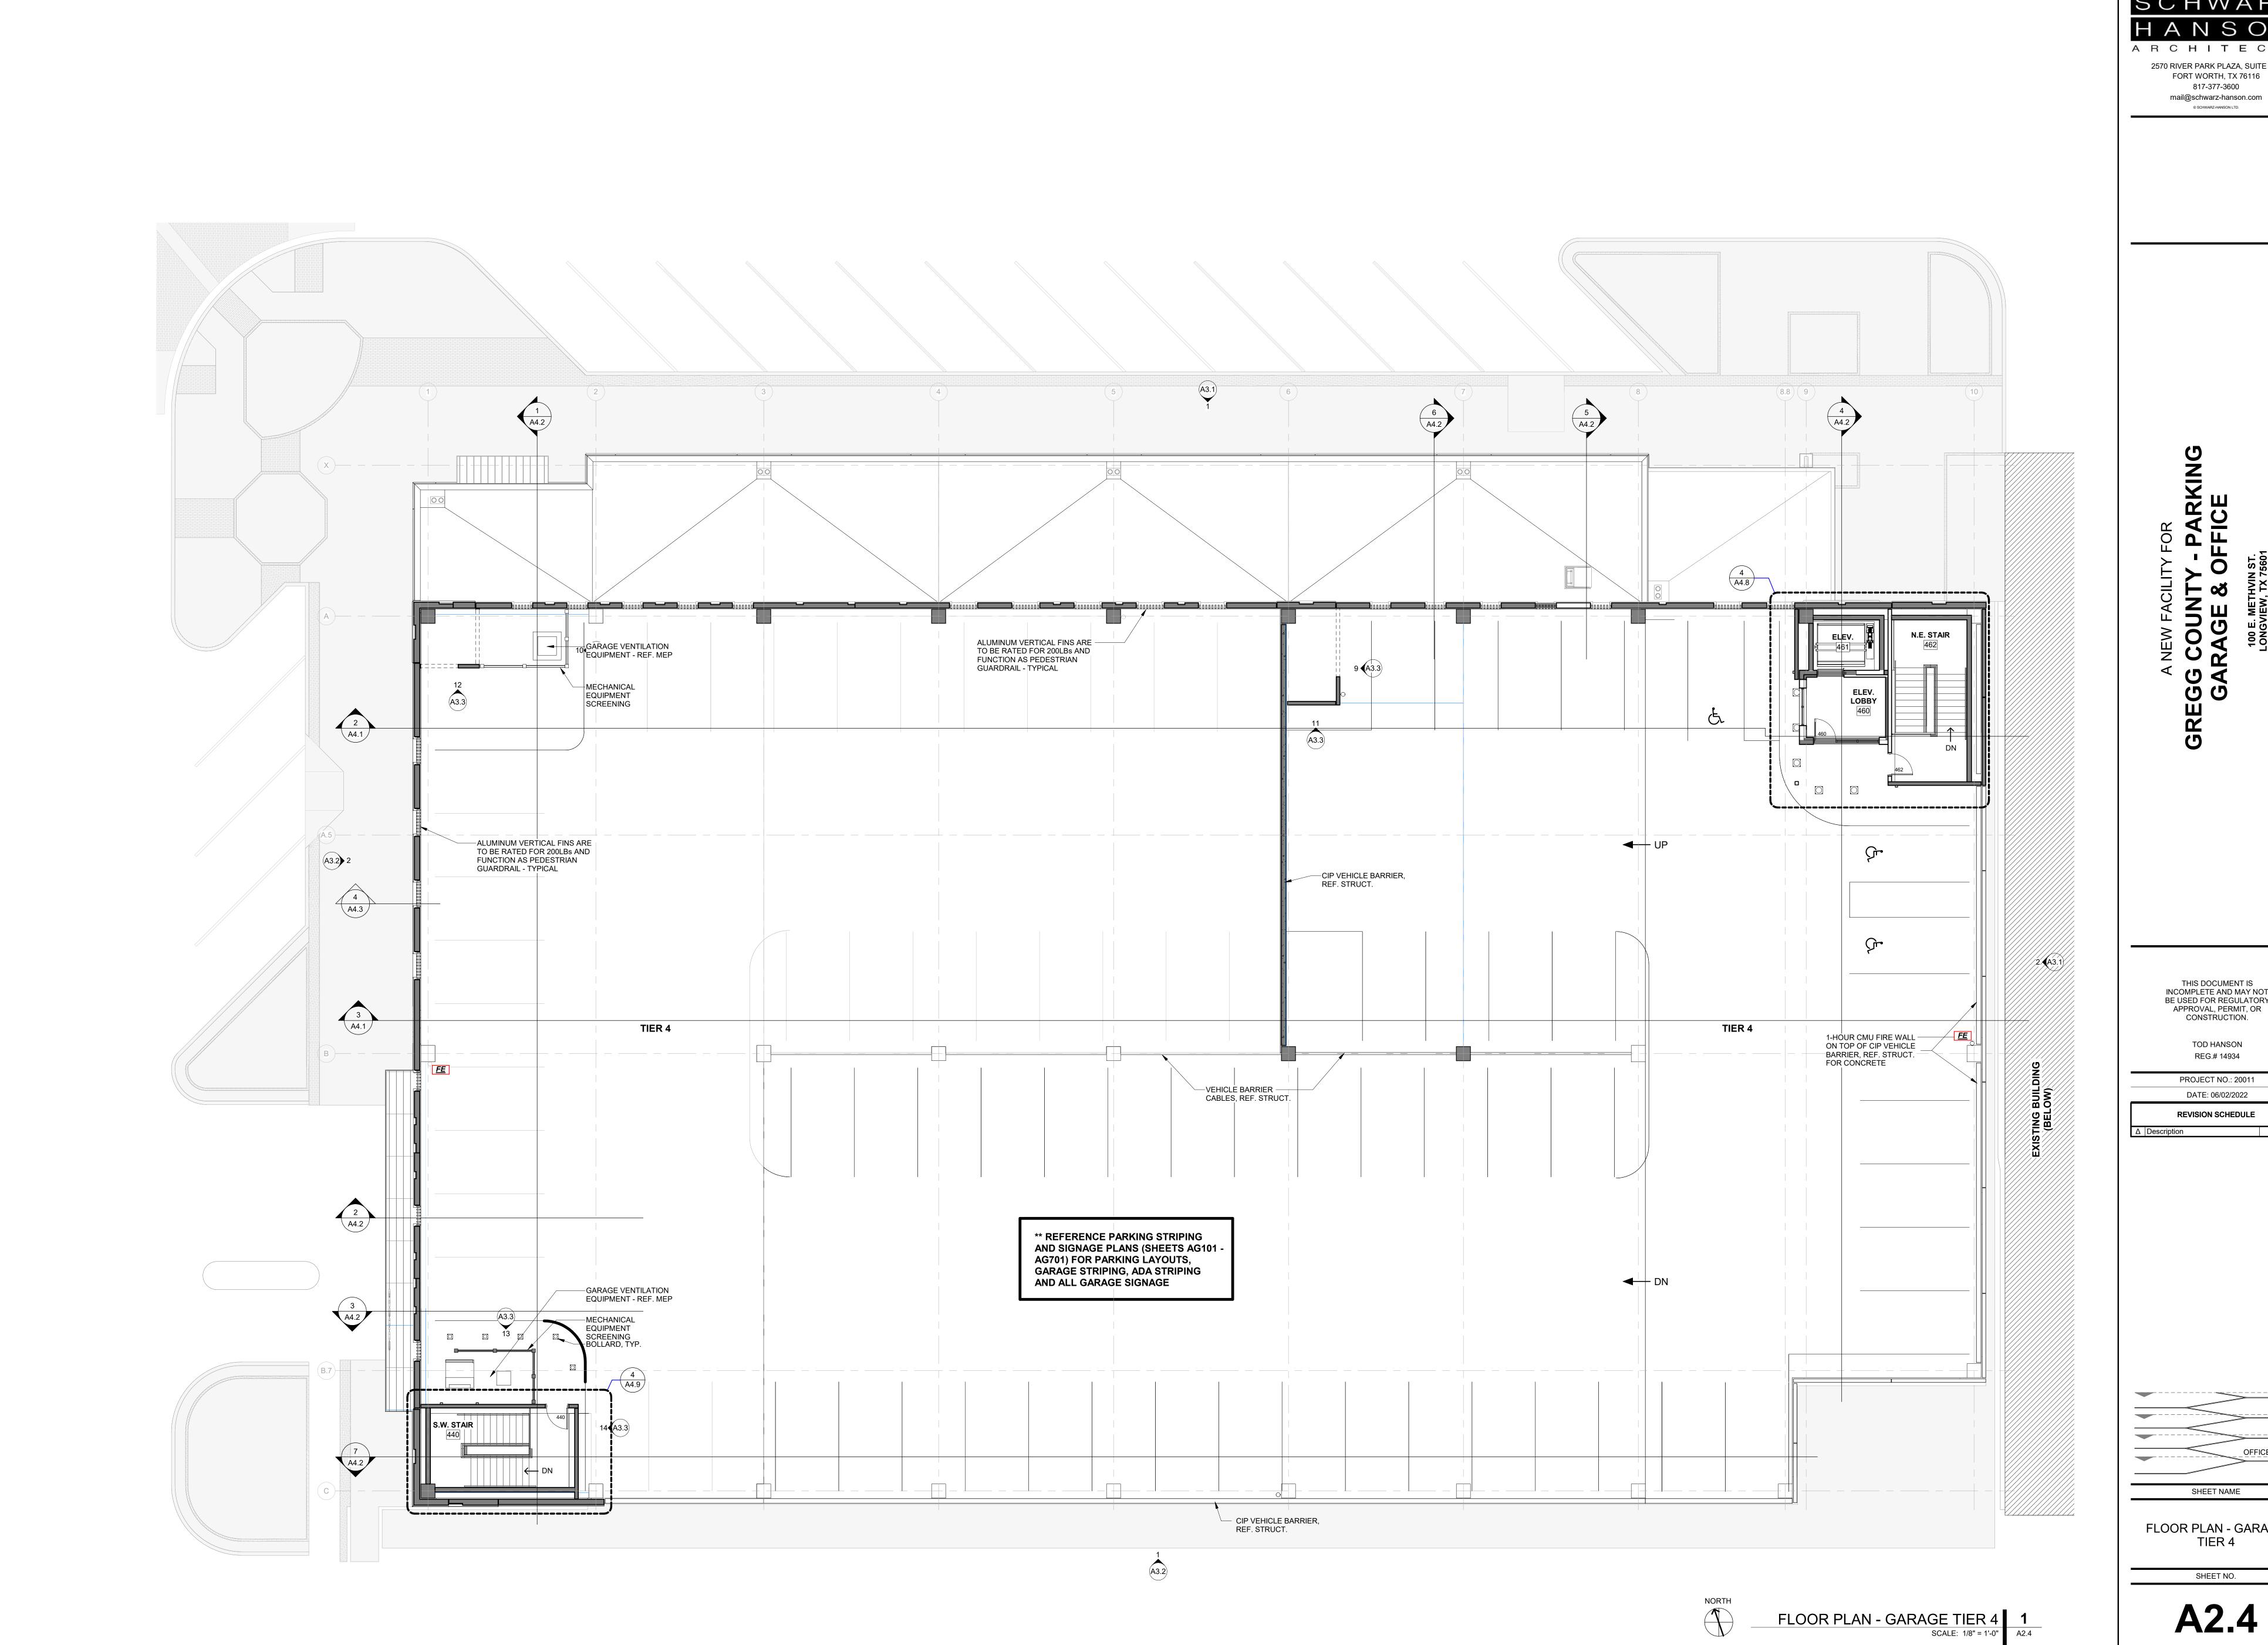
REVISION SCHEDULE

_TIER 2 SHEET NAME

FLOOR PLAN - GARAGE TIER 3

SHEET NO.

A2.3



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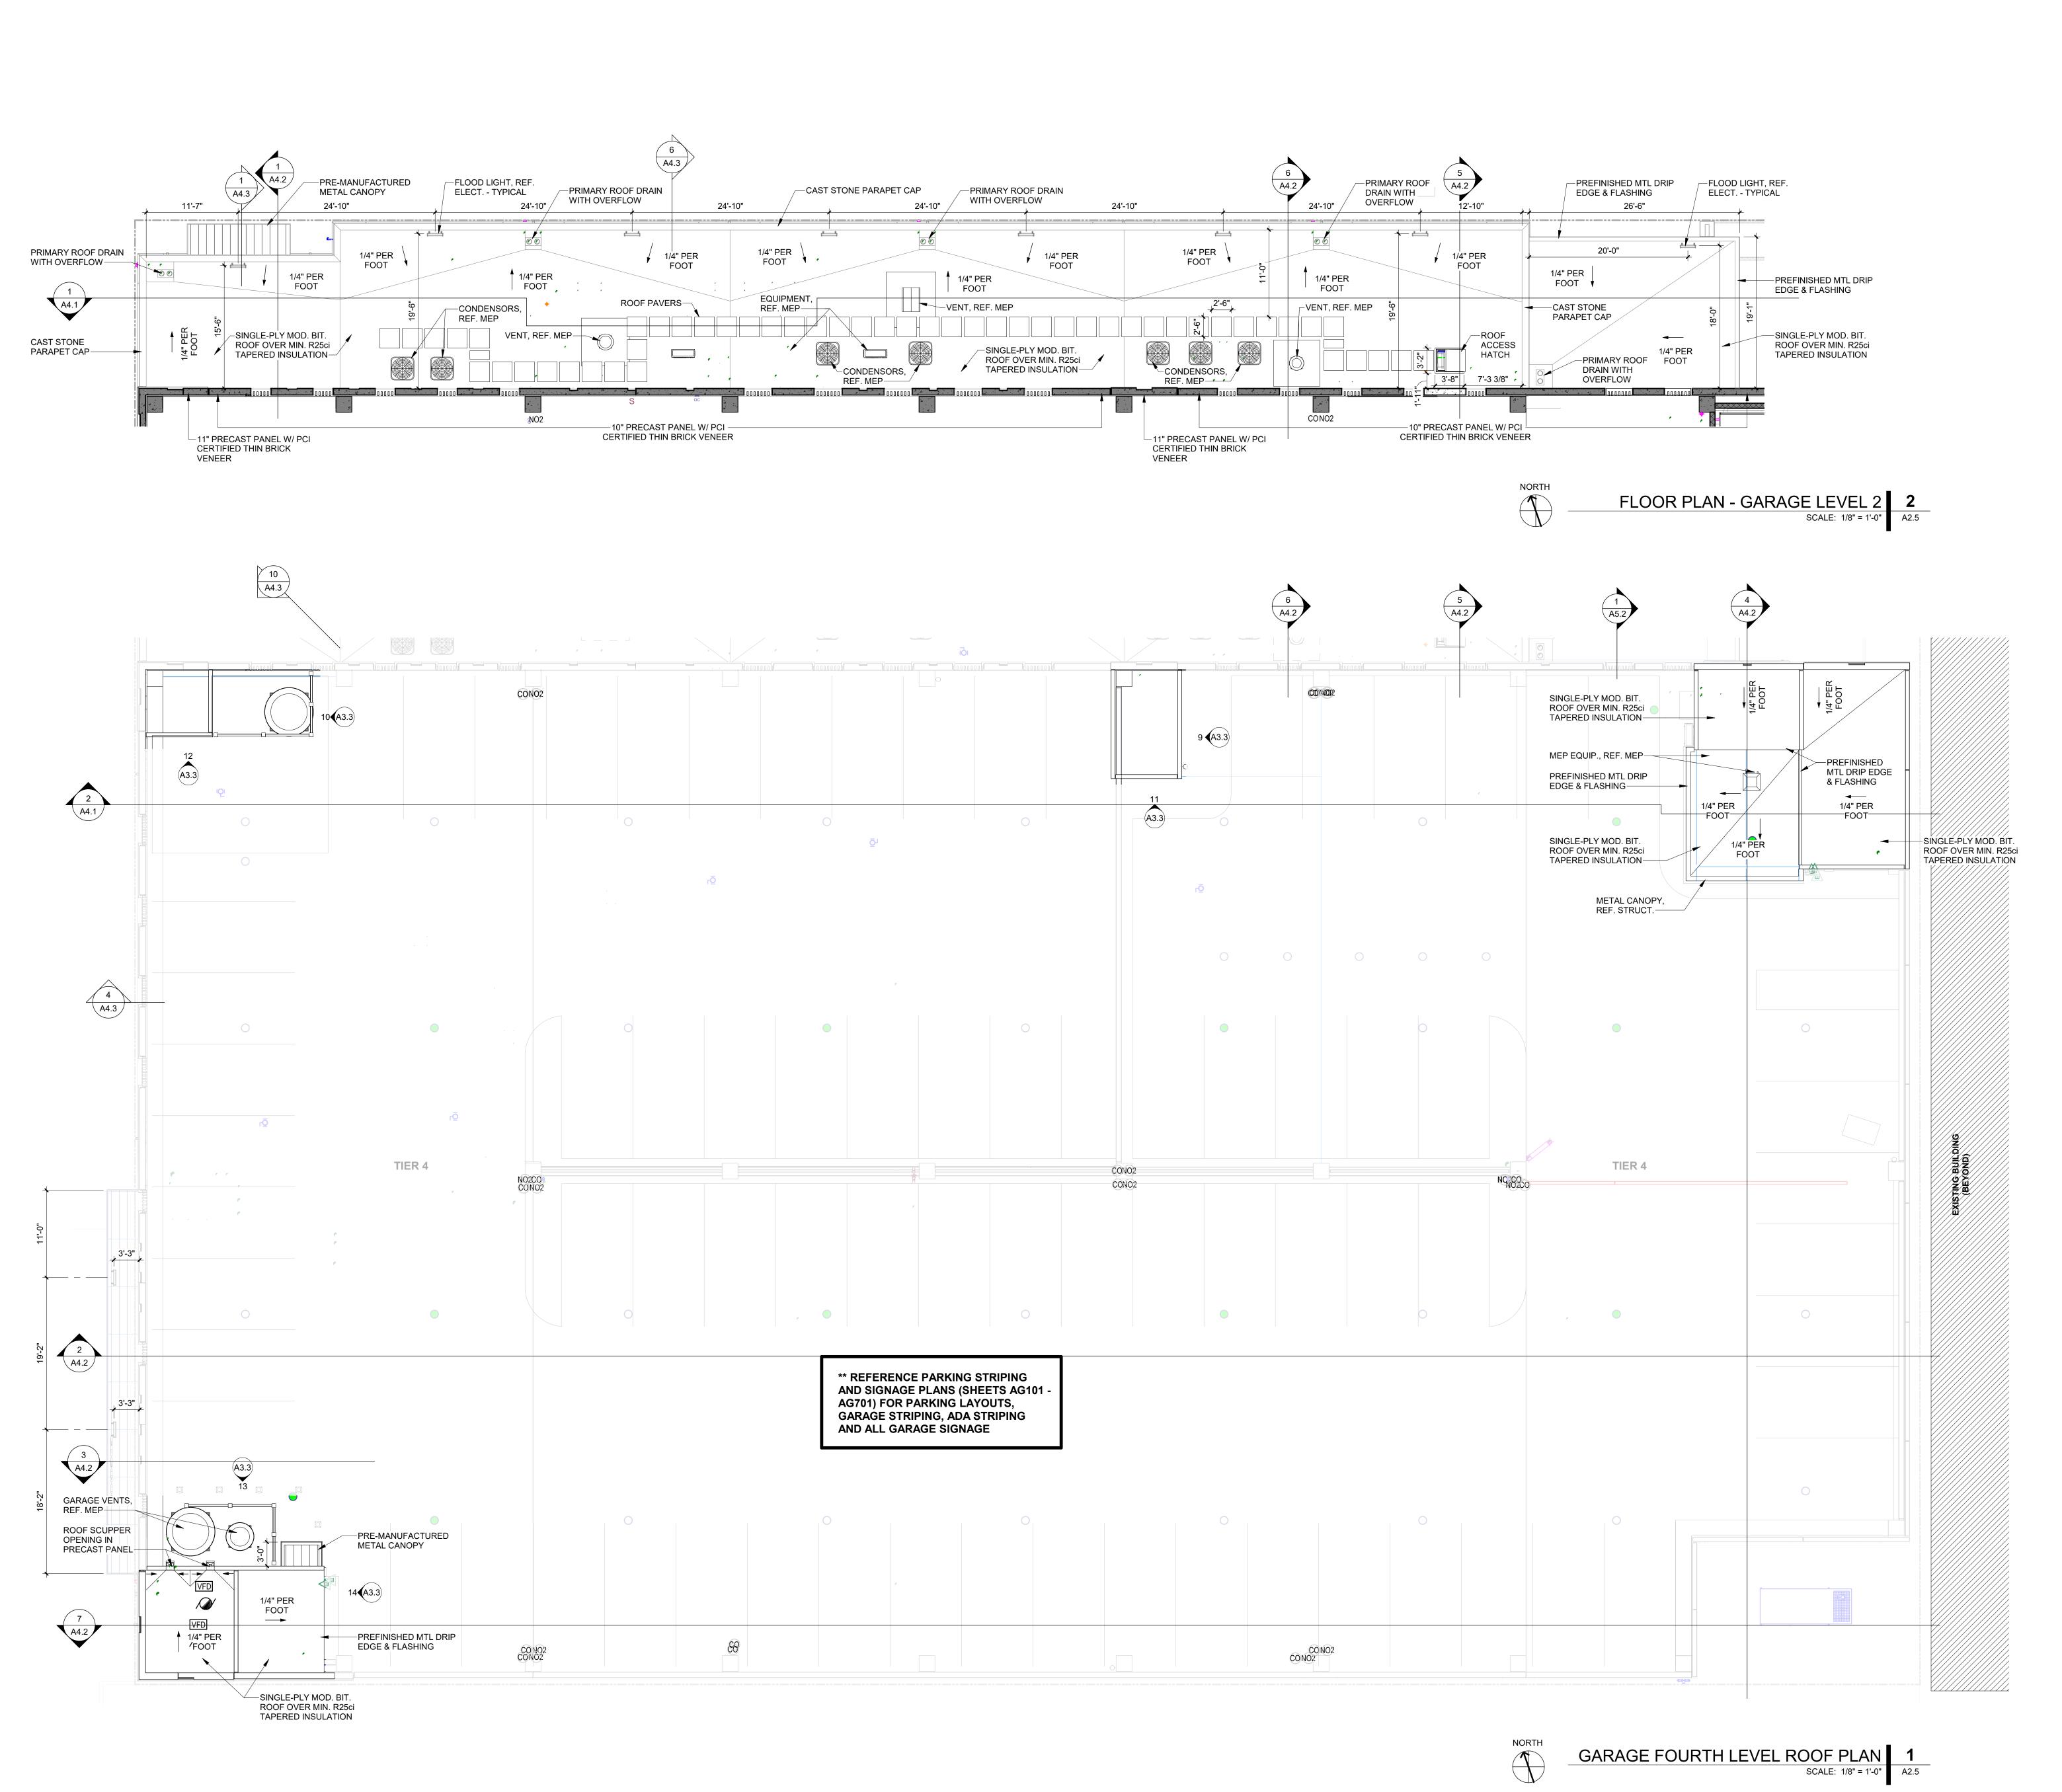
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PROJECT NO.: 20011 DATE: 06/02/2022 **REVISION SCHEDULE**

_TIER 2

FLOOR PLAN - GARAGE TIER 4

SHEET NAME



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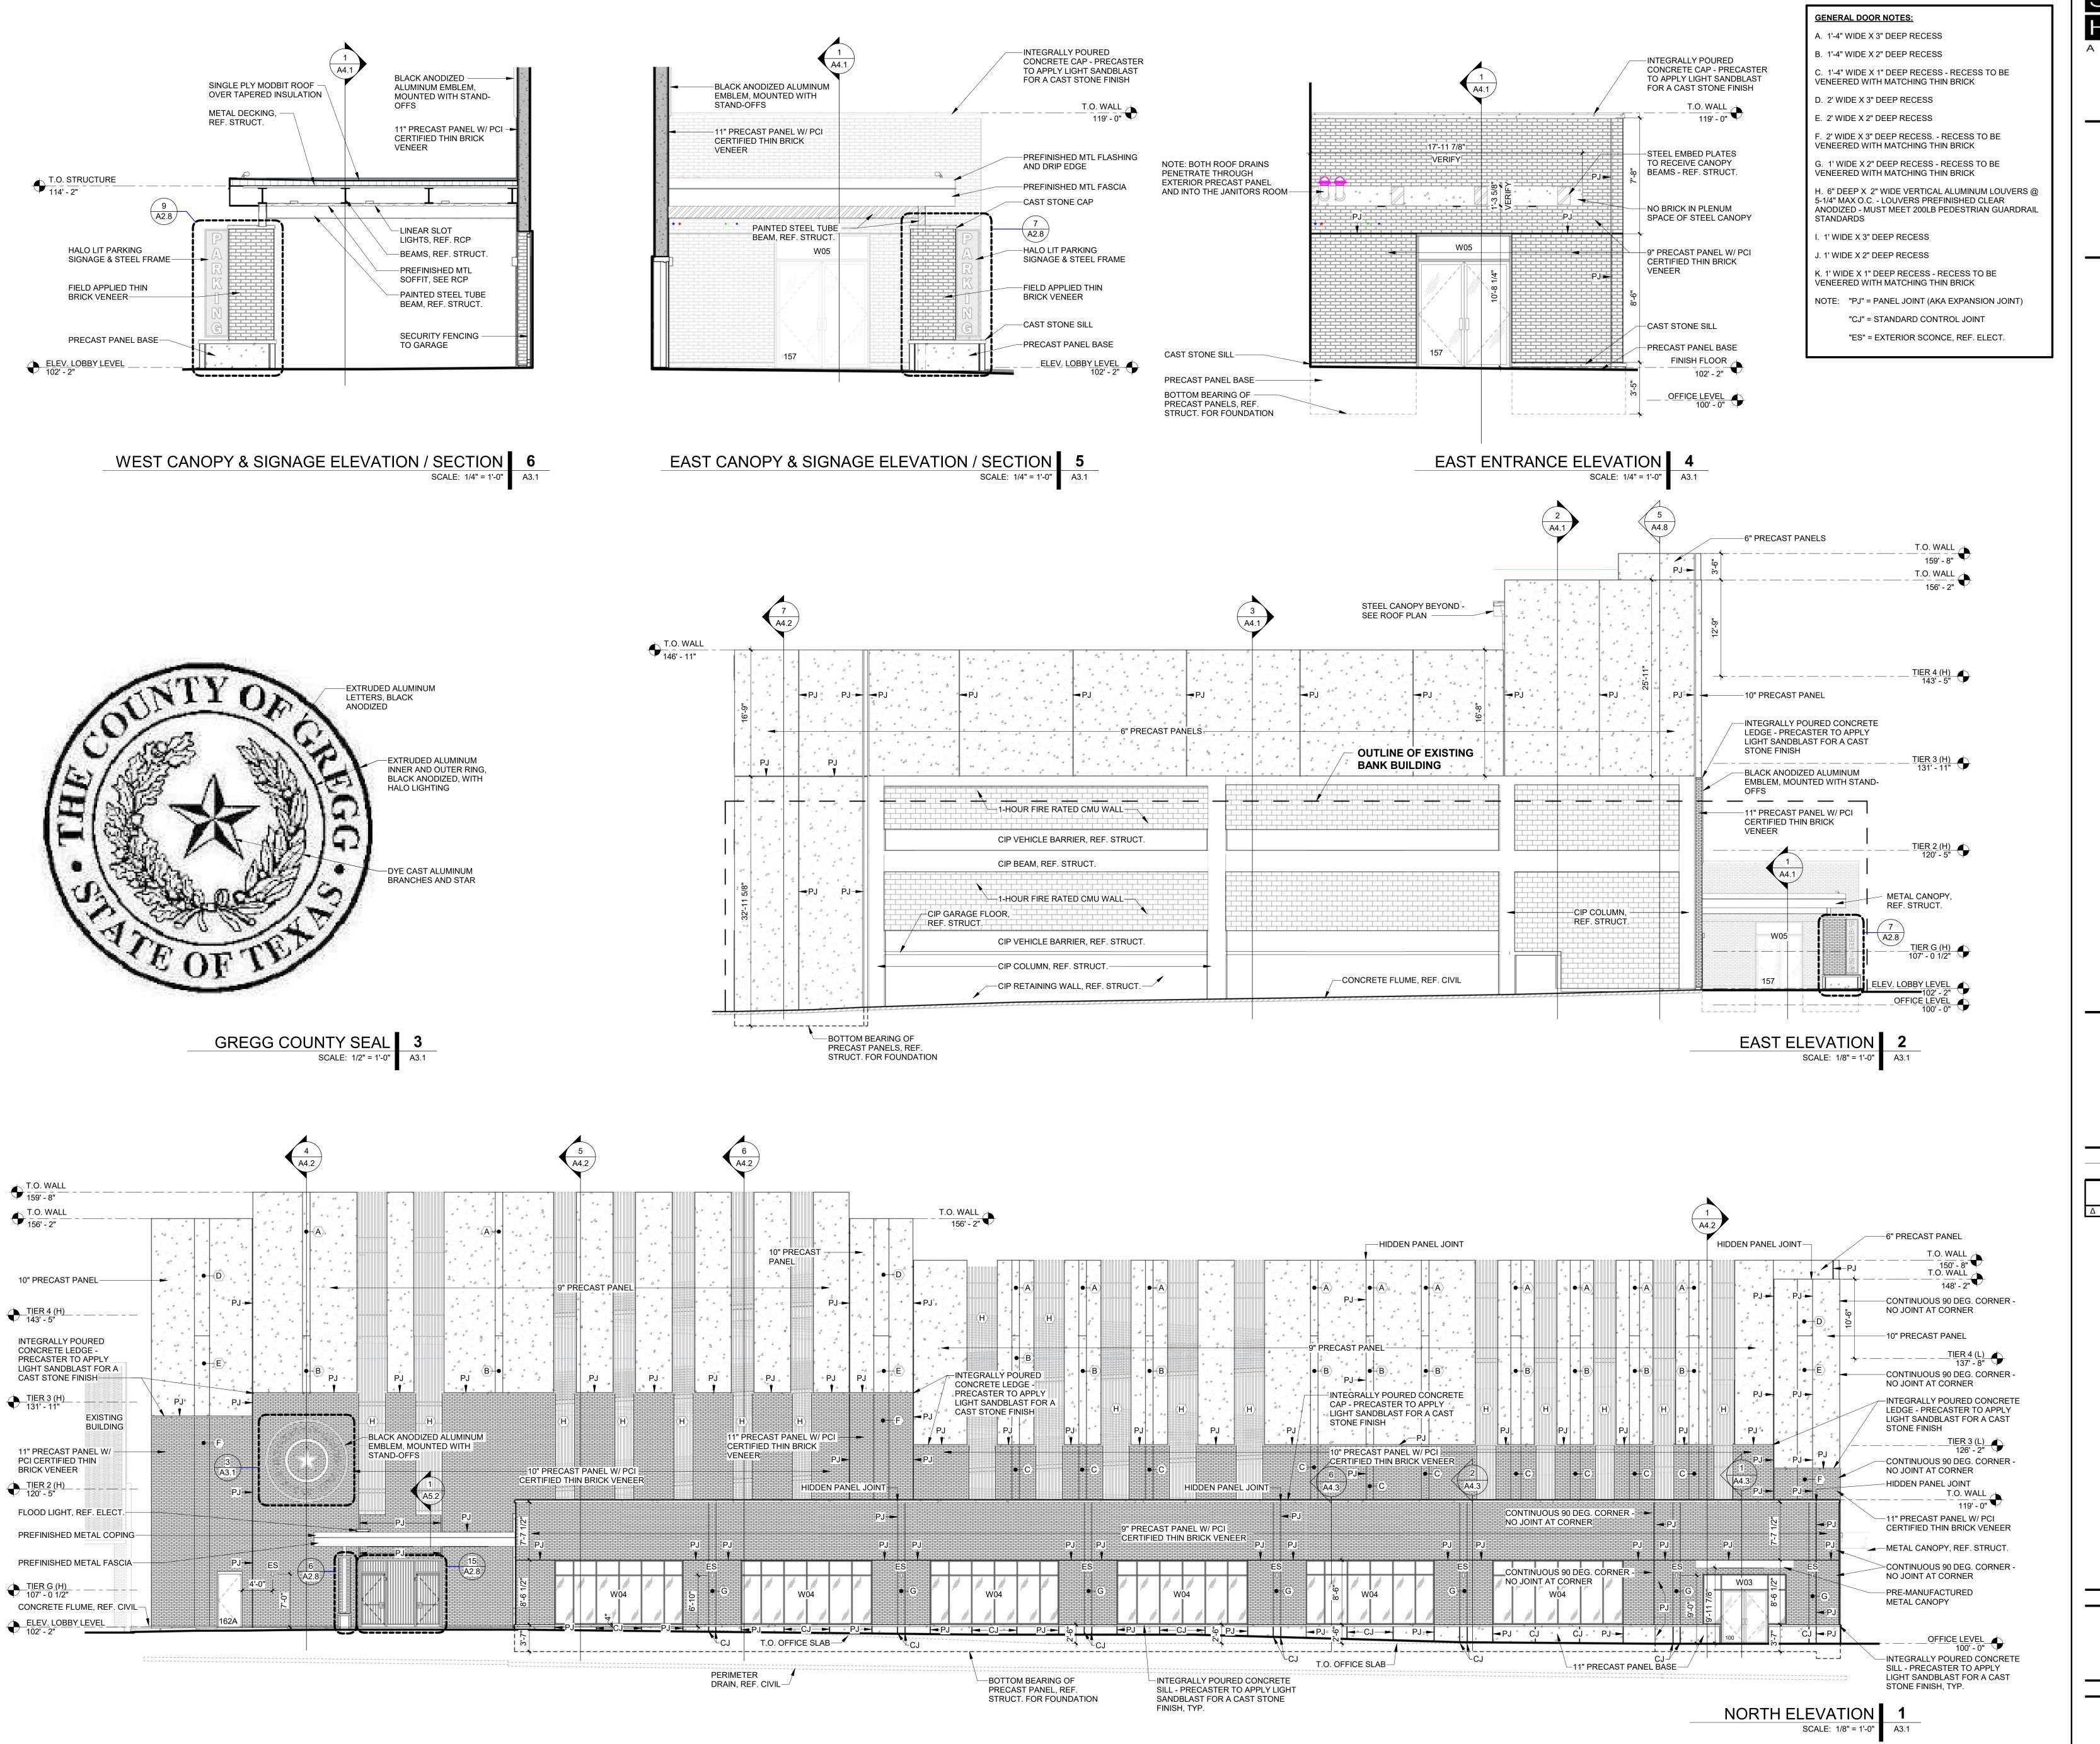
REVISION SCHEDULE

SHEET NAME

ROOF PLAN

SHEET NO.

A2.5



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PROJECT NO.: 20011 DATE: 06/02/2022

REVISION SCHEDULE

Description Date

SHEET NAME

EXTERIOR ELEVATIONS

SHEET NO.

A3.

GENERAL DOOR NOTES: A. 1'-4" WIDE X 3" DEEP RECESS B. 1'-4" WIDE X 2" DEEP RECESS C. 1'-4" WIDE X 1" DEEP RECESS - RECESS TO BE VENEERED WITH MATCHING THIN BRICK D. 2' WIDE X 3" DEEP RECESS E. 2' WIDE X 2" DEEP RECESS F. 2' WIDE X 3" DEEP RECESS. - RECESS TO BE VENEERED WITH MATCHING THIN BRICK G. 1' WIDE X 2" DEEP RECESS - RECESS TO BE VENEERED WITH MATCHING THIN BRICK H. 6" DEEP X 2" WIDE VERTICAL ALUMINUM LOUVERS @ 5-1/4" MAX O.C. - LOUVERS PREFINISHED CLEAR ANODIZED - MUST MEET 200LB PEDESTRIAN GUARDRAIL STANDARDS I. 1' WIDE X 3" DEEP RECESS J. 1' WIDE X 2" DEEP RECESS K. 1' WIDE X 1" DEEP RECESS - RECESS TO BE VENEERED WITH MATCHING THIN BRICK NOTE: "PJ" = PANEL JOINT (AKA EXPANSION JOINT)

"CJ" = STANDARD CONTROL JOINT

"ES" = EXTERIOR SCONCE, REF. ELECT.

T.O. WALL 159' - 8" T.O. WALL 156' - 2" 6" PRECAST PANEL--6" PRECAST PANEL —HIDDEN PANEL JOINT— T.O. WALL 150' - 8" T.O. WALL 150' - 8" T.O. WALL 148' - 2" CONTINUOUS 90 DEG. CORNER -**CONTINUOUS 90** NO JOINT AT CORNER DEG. CORNER - NO JOINT AT CORNER-10" PRECAST PANEL 10" PRECAST PANEL-INTEGRALLY POURED —9" PRECAST PANEL-CONCRETE LEDGE -CONTINUOUS 90 DEG. CORNER -PRECASTER TO APPLY NO JOINT AT CORNER LIGHT SANDBLAST FOR -INTEGRALLY POURED CONCRETE A CAST STONE FINISH-LEDGE - PRECASTER TO APPLY LIGHT SANDBLAST FOR A CAST STONE FINISH A4.1 INTEGRALLY POURED CONCRETE CAP - PRECASTER TO APPLY LIGHT SANDBLAST CONTINUOUS 90 CERTIFIED THIN BRICK VENEER FOR A CAST STONE FINISH— DEG. CORNER - NO —11" PRECAST PANEL W/ PCI JOINT AT CORNER-CERTIFIED THIN BRICK VENEER T.O. WALL - - - - -CONTINUOUS 90 DEG. CORNER -METAL CANOPY, PREFINISHED MTL NO JOINT AT CORNER REF. STRUCT. CONTINUOUS 90 DEG. CORNER -FLASHING, TYP. OPENING FOR BLACK ANODIZED P. STEEL PLATE LETTERS PREFINISHED __ - _ _ _ <u>TIER 2 (L)</u> NO JOINT AT CORNER-MEP LOUVER, VERIFY OPENING METAL FLASHING PRE-MANUFACTURED -SIZE W/ MEP----METAL CANOPY ─INTEGRALLY POURED CONCRETE SILL - PRECASTER TO APPLY EXTERIOR SCONCE (ES)-LIGHT SANDBLAST FOR A CAST CONTINUOUS 90 DEG. CORNER -STONE FINISH, TYP. NO JOINT AT CORNER-PAINTED METAL SECURITY VEHICLE CLEARANCE CONTINUOUS 90 DEG. CORNER - NO JOINT AT FENCING -—PRECAST PANEL BASE BAR --REF. SIGNAGE TYPICAL CORNER-||||PLANS CONTINUOUS 90 DEG. CORNER -OFFICE LEVEL ____ NO JOINT AT CORNER /----PRECAST PANEL BASE FDC, REF. MEP— L-----BOTTOM BEARING OF PRECAST INTEGRALLY POURED CONCRETE — SILL - PRECASTER TO APPLY LIGHT SANDBLAST FOR A CAST INTEGRALLY POURED CONCRETE SILL - PRECASTER TO APPLY LIGHT SANDBLAST FOR A CAST BOTTOM BEARING OF PRECAST PANEL, REF. STRUCT. FOR PREFINISHED METAL -OVERHEAD COILING PANEL, REF. STRUCT. FOR PERIMETER DRAINS, — LEDGE & GRADE BEAM HEIGHTS LEDGE & GRADE BEAM HEIGHTS REF. CIVIL STONE FINISH, TYP. STONE FINISH, TYP.— DOORS

T.O. WALL 159' - 8" T.O. WALL T.O. WALL
156' - 2" T.O. WALL 150' - 8" -HIDDEN PANEL JOINT 9" PRECAST PANEL 6" PRE-CAST PANELS CIP VEHICLE BARRIER, T.O. WALL 148' - 2" REF. STRUCT. -CIP BEAM TO BRACE CONTINUOUS 90 DEG. CORNER -PRECAST PANELS, REF. NO JOINT AT CORNER-STRUCT. —6" PRE-CAST PANELS 10" PRECAST PANEL CIP BEAM, REF. STRUCT. CIP VEHICLE BARRIER, CIP COLUMN - TYPICAL, REF. STRUCT. CIP BEAM, REF. STRUCT. REF. STRUCT. INTEGRALLY POURED CONCRETE LEDGE - PRECASTER TO APPLY LIGHT SANDBLAST FOR A CAST STONE FINISH-CIP BEAM, REF. STRUCT. CIP VEHICLE BARRIER, _REF. STRUCT. CIP BEAM, REF. STRUCT. 11" PRECAST PANEL W/ PCI 11" PRECAST PANEL W/ PCI -CERTIFIED THIN BRICK CERTIFIED THIN BRICK VENEER VENEER BLACK ANODIZED — → 6" PRECAST STEEL PLATE LETTERS PANELS * EXISTING BUILDING METAL CANOPY, REF. STRUCT. -21'-0" 22'-10" V.I.F. INTEGRALLY POURED CONCRETE V.I.F. -STEEL SUPPORTS , EQ , EQ , EQ , V.I.F. SILL - PRECASTER TO APPLY 22'-10" MOUNTED TO CIP CONCRETE - TYP.— -CONCRETE FLUME, NOTE: CUSTOM LIGHT GAUGE STEEL TUBE FENCE TO BE CONSTRUCTED IN THE FIELD - PRIMARY LIGHT SANDBLAST FOR A CAST V.I.F. 22'-10" REF. CIVIL STONE FINISH, TYP.-CIP RETAINING WALL, REF. STRUCT.— VERTICAL POSTS ARE 2-1/2" TUBE STEEL, PRIMARY 22'-10" V.I.F. STEEL SUPPORTS HORIZONTAL MEMBERS ARE 1-1/2" TUBE STEEL AND MOUNTED TO CIP CONCRETE - TYP. V.I.F. _VERTICAL PICKETS ARE 1" TUBE STEEL. ALL STEEL, TO BE PRE-GALVANIZED - TYPICAL CONTINUOUS 90 DEG. CORNER - NO JOINT AT CORNER ü-----BOTTOM BEARING OF PRECAST PANEL, REF. STRUCT. FOR LEDGE & GRADE BEAM HEIGHTS PRECAST PANEL BASE + ------PERIMETER DRAIN, REF. CIVIL -BOTTOM BEARING OF PRECAST PANEL, REF. STRUCT. FOR LEDGE & GRADE BEAM HEIGHTS

> SOUTH ELEVATION SCALE: 1/8" = 1'-0"

WEST ELEVATION

SCALE: 1/8" = 1'-0"

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SHEET NAME

EXTERIOR ELEVATIONS