
DOCUMENTS FOR A ROOF REPLACEMENT PROJECT AT:

GREGG COUNTY - COURTHOUSE ROOFING PROJECT PHASE 1 BID#2017-703

101 East Methvin, Longview, TX 75601

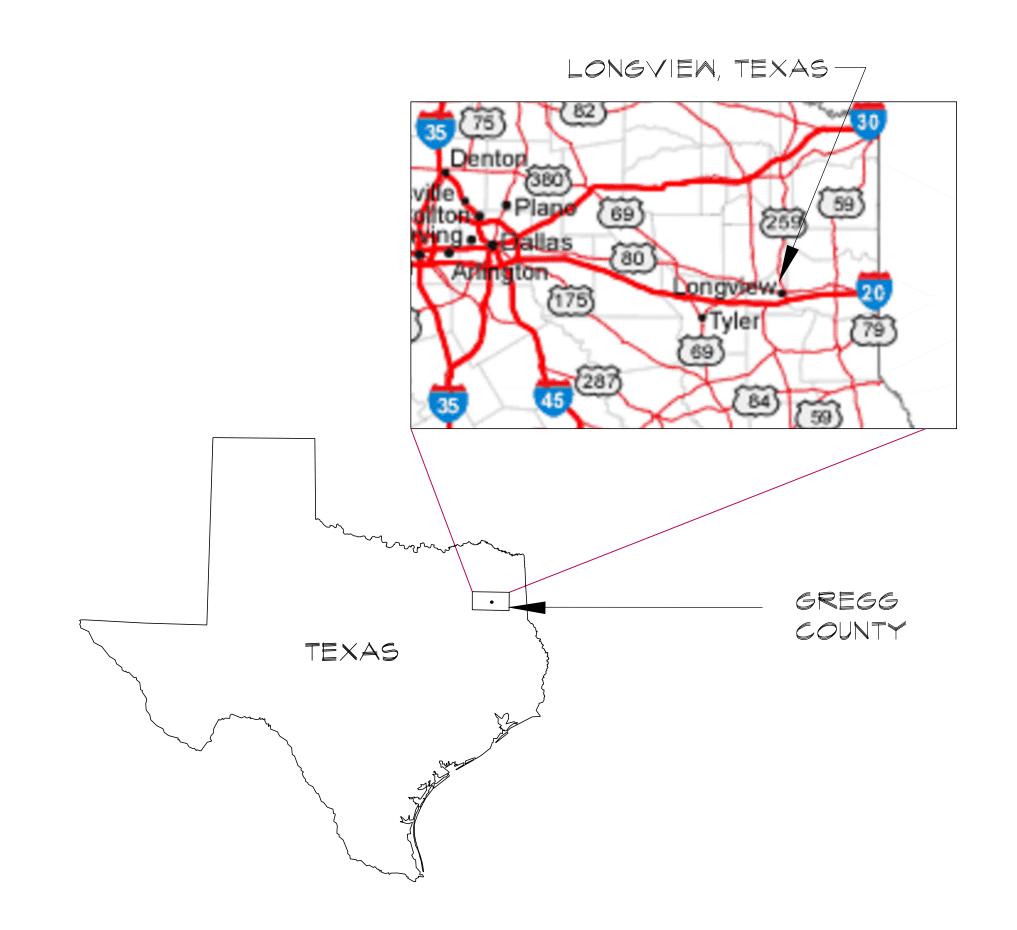

ROOF DESIGN BY:



roof consulting & design

DEN OFFICE 616 SOUTH COPPELL RD COPPELL, TX 75019 PHONE: 214.758.0785 FAX: 214.792.9548

ARCHITECTURAL SHEETS

COVER SHEET, LOCATION MAP, SHEET INDEX GENERAL NOTES, ROOF SYSTEMS AERIAL SITE PLAN ROOF PLAN (DEMOLITION AND PREPARATION) PARTIAL ROOF PLAN (DEMOLITION AND PREPARATION) PARTIAL ROOF PLAN (DEMOLITION AND PREPARATION) ROOF PLAN (NEW WORK) PARTIAL ROOF PLAN (NEW WORK) PARTIAL ROOF PLAN (NEW WORK) LWC POUR LAYOUT PLAN DETAILS DETAILS A-501 DETAILS DETAILS A-5Ø4 DETAILS DETAILS DETAILS DETAILS DETAILS DETAILS DETAILS ROOF DRAIN LAYOUT

CODE ANALYSIS:

INTERNATIONAL ELECTRICAL CODE (NEC), 2011 INTERNATIONAL PLUMBING CODE(IPC), 2012 INTERNATIONAL MECHANICAL CODE(IMC), 2012 INTERNATIONAL FIRE CODE (IFC), 2012

INTERNATIONAL BUILDING CODE (IBC), 2012

INTERNATIONAL ENERGY CONSERVATION CODE (IECC), 2015

616 SOUTH COPPELL RD

ISSUED FOR

G-001 COVER SHEET


CHECKED BY:

SHEET TITLE:
COVER SHEET LOCATION MAP SHEET INDEX

G-001


GREGG COUNTY, TEXAS VICINITY MAP



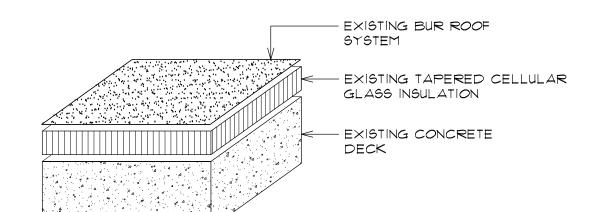


AREA: D



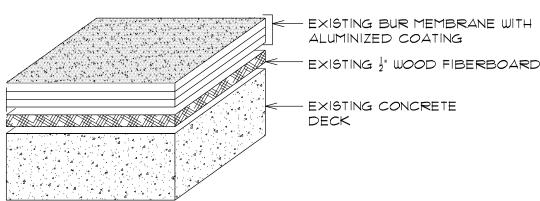


AREA: DI



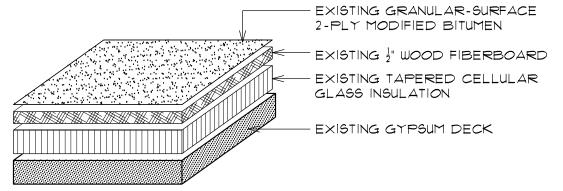

AREA: N



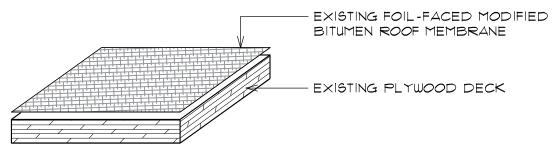

EXISTING GRAVEL-SURFACE

— EXISTING 3" CELLULAR GLASS


BUR MEMBRANE SYSTEM

- EXISTING GYPSUM DECK

INSULATION

AREA: N TUNNEL-WAY




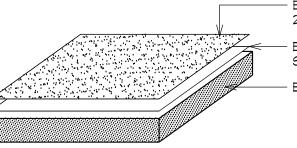

EXISTING GRANULAR-SURFACE 2-PLY MODIFIED BITUMEN — EXISTING FIBERGLASS BASE SHEET - EXISTING GYPSUM DECK


AREA: NI



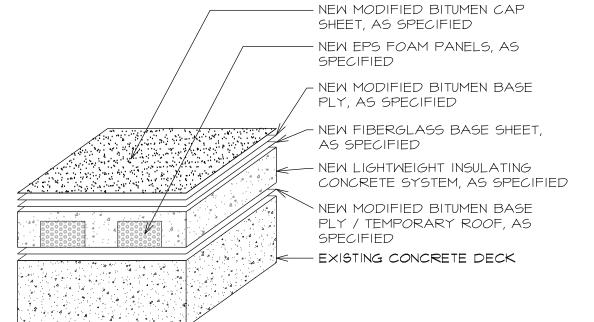


AREA: D

NEW ROOF SYSTEM

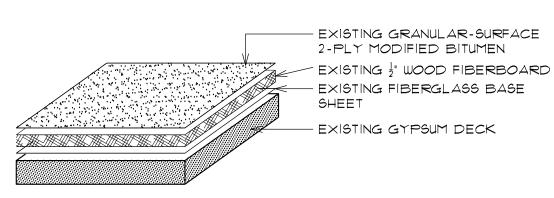

AREA: N2



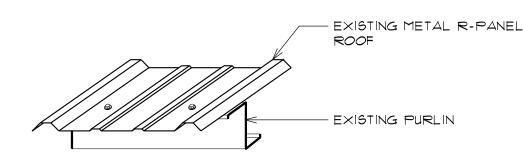


AREA: O

AREA: N TUNNEL-WAY


SCALE: N.T.S.



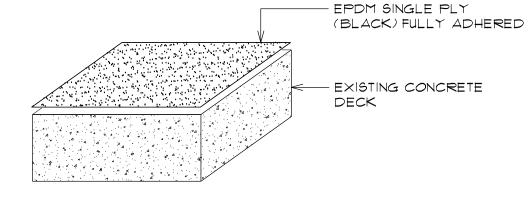


AREA: P EXISTING ROOF SYSTEM [A-ØØ] SCALE: N.T.S.



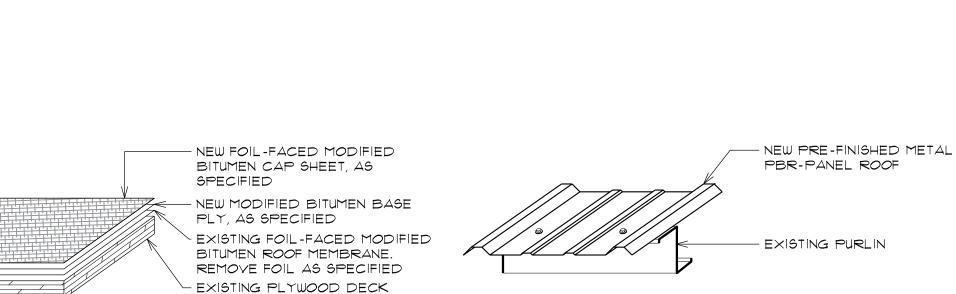

AREA: O



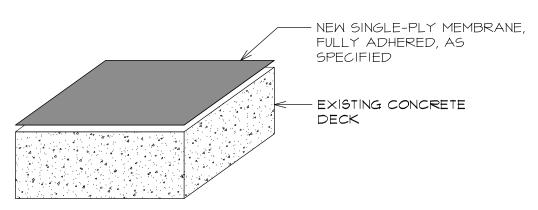

AREA: P





GENERAL PROJECT NOTES:

AREAS: N, N1, N2, Q, R, & S

- A. PROVIDE BUILDING PERMIT FROM CITY OF LONGVIEW, TX.
- B. ALL DIMENSIONS ARE APPROXIMATE. CONTRACTOR TO FIELD VERIFY.
- C. FURNISH OWNER WITH 2 YEAR CONTRACTOR WARRANTY ON ALL WORK PERFORMED.
- D. CONTRACTOR SHALL COORDINATE WORK EFFORTS TO COMPLETE THE WORK WITHIN THE CONTRACT PERIOD. WORK SHALL BE STAGED AND COORDINATED SUCH THAT WORK PROGRESS SHALL NOT REQUIRE MATERIAL OR FOOT TRAFFIC TO TRAVERSE OVER NEWLY INSTALLED ROOFING. CONTRACTOR SHALL STAGE EQUIPMENT AND MATERIALS IN OWNER DESIGNATED AREAS ONLY.

NEW MODIFIED BITUMEN CAP

NEW MODIFIED BITUMEN BASE

NEW FIBERGLASS BASE SHEET

NEW LIGHTWEIGHT INSULATING

CONCRETE SYSTEM, AS SPECIFIED

NEW SMOOTH-SURFACE MODIFIED

BITUMEN BASE PLY/ TEMPORARY

NEW BASE SHEET MECHANICALLY

ATTACHED, AS SPECIFIED

EXISTING GYPSUM DECK

SHEET, AS SPECIFIED

PLY, AS SPECIFIED

ROOF, AS SPECIFIED

AS SPECIFIED

- E. INSTALL NEW LIGHTWEIGHT INSULATING CONCRETE AS SHOWN INCLUDING CRICKETS WHERE SHOWN WITH POSITIVE SLOPE FOR DRAINAGE ON THE UPHILL SIDE OF ALL CURBS 2 FEET OR GREATER, CRICKET SLOPE TO BE 2X FINISHED ROOF SLOPE.
- F. ABSOLUTELY NO PONDING WATER (AS DEFINED BY NRCA) WILL BE ALLOWED.
- G. CONTRACTOR SHALL BE RESPONSIBLE FOR HER/HIS CONSTRUCTION MEANS AND METHODS. CONTRACTOR IS SOLELY RESPONSIBLE FOR HER/HIS SAFETY MEASURES TO PROTECT EMPLOYEES, PATRONS, VISITORS, ETC. WORK SHALL BE PROTECTED FROM AND NOT INTERFERE WITH OWNERS DAILY OPERATIONS UNLESS COORDINATED WITH SUCH.
- H. CONTRACTOR SHALL WALK SITE PRIOR TO COMMENCEMENT OF ANY WORK AND PROVIDE PHOTOGRAPHIC DOCUMENTATION OF EXISTING CONDITIONS, CONTRACTOR SHALL VERIFY WORKING CONDITION OF ALL MECHANICAL, ELECTRICAL, AND PLUMBING EQUIPMENT. PROVIDE WRITTEN DOCUMENTATION OF CONDITION TO OWNER PRIOR TO COMMENCEMENT OF WORK.
- CONTRACTOR SHALL BE RESPONSIBLE TO REPAIR OR REPLACE DAMAGE TO ANY BUILDING, SITE COMPONENT, OR ADJACENT PROPERTY CAUSED BY CONSTRUCTION TO THE SATISFACTION OF THE OWNER.
- J. CONTRACTOR SHALL CONFORM TO ALL APPLICABLE FEDERAL, STATE, LOCAL OR OTHER APPLICABLE REGULATORY AGENCY BUILDING CODES, LAWS, RULES AND REGULATIONS. WORK DETAILED ON THESE PLANS SHALL BE COMPLETED ACCORDING TO THE PROJECT DOCUMENTS. IF CONFLICT ARISES BETWEEN CODE AND PROJECT DOCUMENTS, CONTRACTOR SHALL IMMEDIATELY NOTIFY THE A/E FOR CLARIFICATION.
- K. CONTRACTOR SHALL PROVIDE AND MAINTAIN A PROJECT SIGN WITH EMERGENCY CONTACT PHONE NUMBERS.
- L. WHERE DETAILS ARE NOT SHOWN, CONTRACTOR SHALL CONFORM TO SIMILAR WORK ON THE PROJECT. IN THE ABSENCE OF SPECIFICATIONS COVERING THE INSTALLATION OF A PRODUCT, THE CONTRACTOR SHALL CONFORM TO THE LATEST EDITION OF THE MANUFACTURER'S WRITTEN SPECIFICATION.
- M. ALL WORK PERFORMED BY THE CONTRACTOR AND HER/HIS SUBCONTRACTORS SHALL CONFORM TO THE PROJECT DOCUMENTS. ANY WORK DEEMED DEFECTIVE OR UNACCEPTABLE BY THE OWNER OR A/E SHALL BE REPAIRED OR REPLACED TO THE SATISFACTION OF THE OWNER.

GENERAL PROJECT NOTES: (CONT.)

- N. SOME STRUCTURAL, MECHANICAL, MASONRY, ELECTRICAL, AND PLUMBING MODIFICATIONS MAY BE REQUIRED. CONTRACTOR SHALL PROVIDE LICENSED SUB-CONTRACTOR TO PERFORM SAID WORK.
- O. ALL GAS PIPING AND ELECTRICAL CONDUIT ROUTING/CONNECTION TO ROOF TOP UNITS SHALL COMPLY WITH CURRENT MECHANICAL AND ELECTRICAL CODE REQUIREMENTS AS REQUIRED. (INCLUDING FLEX CONDUIT CONNECTIONS TO ROOF TOP UNITS)
- P. CONTRACTOR SHALL BE RESPONSIBLE FOR DELIVERY, RECEIVING, AND PROPER STORAGE OF MATERIALS AND EQUIPMENT AT THE SITE IN DESIGNATED "LAY-DOWN AREA" DENOTED ON PLAN. CONTRACTOR SHALL INSPECT EQUIPMENT AND MATERIALS, REJECTING ANY DAMAGED OR DEFECTIVE MATERIALS OR EQUIPMENT. MATERIALS DEEMED DEFECTIVE OR UNACCEPTABLE BY THE A/E SHALL BE REMOVED FROM THE SITE WITHIN TWENTY-FOUR (24) HOURS.
- Q. ALL ROOFING MATERIAL SHOWN SHALL BE CONSIDERED NEW PRODUCT UNLESS NOTED OTHERWISE.
- R. PROVIDE ALL NEW FLASHINGS OF A TYPE AND MATERIAL AS REQUIRED BY ROOFING MEMBRANE MANUFACTURER FOR REQUIRED 20 YEAR WARRANTY.
- 5. ALL BASE FLASHING HEIGHTS MUST MEET A MINIMUM 8 INCHES HEIGHT. SOME CURBS, METAL SIDING, COUNTERFLASHING AND EQUIPMENT MAY NEED TO BE RAISED TO ALLOW FOR A MINIMUM 8 INCH BASE FLASHING HEIGHT, CONTRACTOR TO REMOVE AND STORE EQUIPMENT FOR REINSTALLATION AS NECESSARY. CONTRACTOR WILL RAISE CURBS, EXTEND DUCTWORK, AND EXTEND PIPES AS NECESSARY TO PROVIDE 8 INCH MINIMUM BASE FLASHING
- T. INSTALL NEW WALKPADS WHERE REQUIRED, AND AT ALL ACCESS POINTS AND AROUND ALL SERVICEABLE EQUIPMENT, PATHWAYS, AS SPECIFIED AND AS SHOWN ON THE ABOVE DETAILS.
- U. PROVIDE ALL NEW COUNTERFLASHINGS, TERMINATION BARS, METAL PENETRATION FLASHINGS AS SHOWN ON DETAILS ABOVE, AND OF A TYPE AND MATERIAL AS REQUIRED BY ROOFING MEMBRANE MANUFACTURER FOR REQUIRED 20 YEAR WARRANTY.
- V. CONTRACTOR SHALL CLEAN JOB SITE DAILY AND SWEEP GROUNDS WITH A MAGNET IN ORDER TO PICK UP ALL NAILS, SCREWS, AND OTHER METALLIC OBJECTS.

SCOPE OF MORK:

- A. BUILDING ROOF AREAS D, N, N-1, N-2, O, P, Q, R, & S : REMOVE EXISTING ROOF SYSTEMS AS SHOWN ON DEMOLITION PLAN AND AND INSTALL NEW ROOF SYSTEM AS SHOWN ON DETAILS
- B. BUILDING ROOF AREA D-I WILL BE ENCLOSED AND BECOME PART OF ROOF AREA D. NEW ROOF ACCESS WILL BE PROVIDED AS SHOWN ON DETAILS ABOVE.
- C. BUILDING ROOF AREA D FLAT METAL PANELS WILL BE INSTALLED TO ALL HORIZONTAL BAR NETWORKS AS SHOWN ON DETAILS HEREIN. ALL SUCH AREAS WILL BE CONSTRUCTED TO BE LEVEL WITH SURROUNDING SURFACES OF EXISTING CONCRETE ROOF DECK USING APPROVED INSULATION AND MADE WATER TIGHT USING THE SPECIFIED TEMPORARY ROOF.
- D. BUILDING ROOF AREA Q GAS AND ELECTRICAL LINE WILL BE DISCONNECTED. A CURB WILL BE CONSTRUCTED, FLASHED AND CAPPED TO HOUSE STUBBED SUPPLY LINES FOR FUTURE USE AS DETAILED HEREIN.
- E. BUILDING ROOF AREAN TUNNEL WAY. EXISTING FOIL-FACED ROOF MEMBRANE WILL REMAIN IN PLACE THROUGHOUT DEMOLITION, INSTALLATION OF TEMPORARY ROOF AND LIGHTWEIGHT INSULATING CONCRETE SYSTEM. FOIL SURFACING WILL BE REMOVED AS DIRECTED BY THE MANUFACTURER OF THE NEW ROOF SYSTEM, AND IMMEDIATELY PRIOR TO INSTALLATION OF NEW FOIL-FACED ROOF SYSTEM AS SPECIFIED AND AS SHOWN ON DETAILS ABOVE ..
- F. BUILDING ROOF AREA N-2 NEW DRAINS LEADERS AND PIPING WILL BE INSTALLED TO CONVEY WATER BENEATH AREA N-2 AND AREA N FOR DOWNSPOUT DELIVERY ONTO ROOF AREA O.
- G. NEW CONDENSATE LINE WILL BE INSTALLED TO TRANSPORT HVAC UNIT CONDENSATION TO NEW DRAIN LEADER LOCATED AT ROOF AREA N-2.
- H. DUCTWORK FOR ROOF AREA N-2 WILL BE FRAMED AND WATERPROOFED TO ALLOW FOR FUTURE ACCESS AS DETAILED HEREIN.

Consulting Group. LLC roof consulting & design

DFW OFFICE 616 SOUTH COPPELL RD COPPELL, TX 75019 PHONE:214.758.0785

AMARILLO OFFICE 7120 I-40 WEST, SUITE 210 AMARILLO, TX 79106 PHONE: 806.356.6059

ISSUED FOR NOT FOR CONSTRUCTION THESE DOCUMENTS ARE FOR BIDDING PURPOSES ONLY. NOT TO BE USED FOR CONSTRUCTION.

S OURTHOU -703 SEMENT #201 REPL GG

GREC GREC PHAS BID#Z A ROOF F DESCRIPTION: ISSUE FOR BID SET

PROJECT NO: 1-132-1 CAD DWG FILE: A-001 GENERAL NOTES DRAWN BY: CHECKED BY: OCCUPANCY GROUP: **GROUP A**

SHEET TITLE: GENERAL NOTES ROOF SYSTEMS








- AREA OF CONSTRUCTION



2 ENLARGED AERIAL SITE PLAN A-100 SCALE: 1/2" = 1'-0"

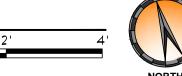





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COURTHOUSE


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REV. DATE:				DESCRIPTION:					
0	01/27/201		7	ISSUE FOR BID SET					
PROJECT NO:			•	1-132	-1				
CAD DWG FILE:			AS-100 AERIAL SITE PLAN						
DRAWN BY:			AA						
CHECKED BY:			VC						
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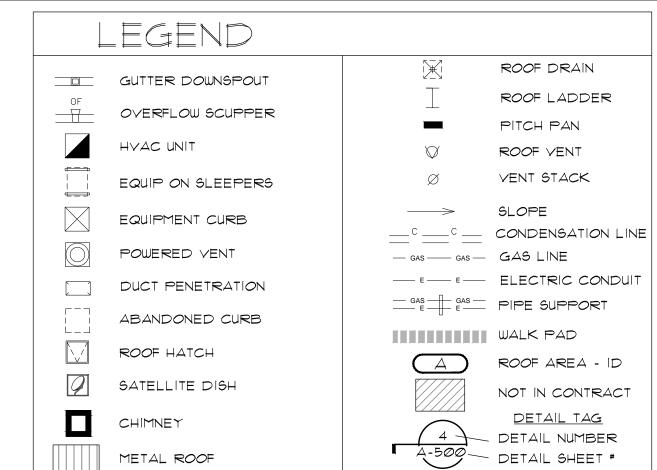
OCCUPANCY
GROUP:

SHEET TITLE:

AERIAL SITE PLAN

AS-100



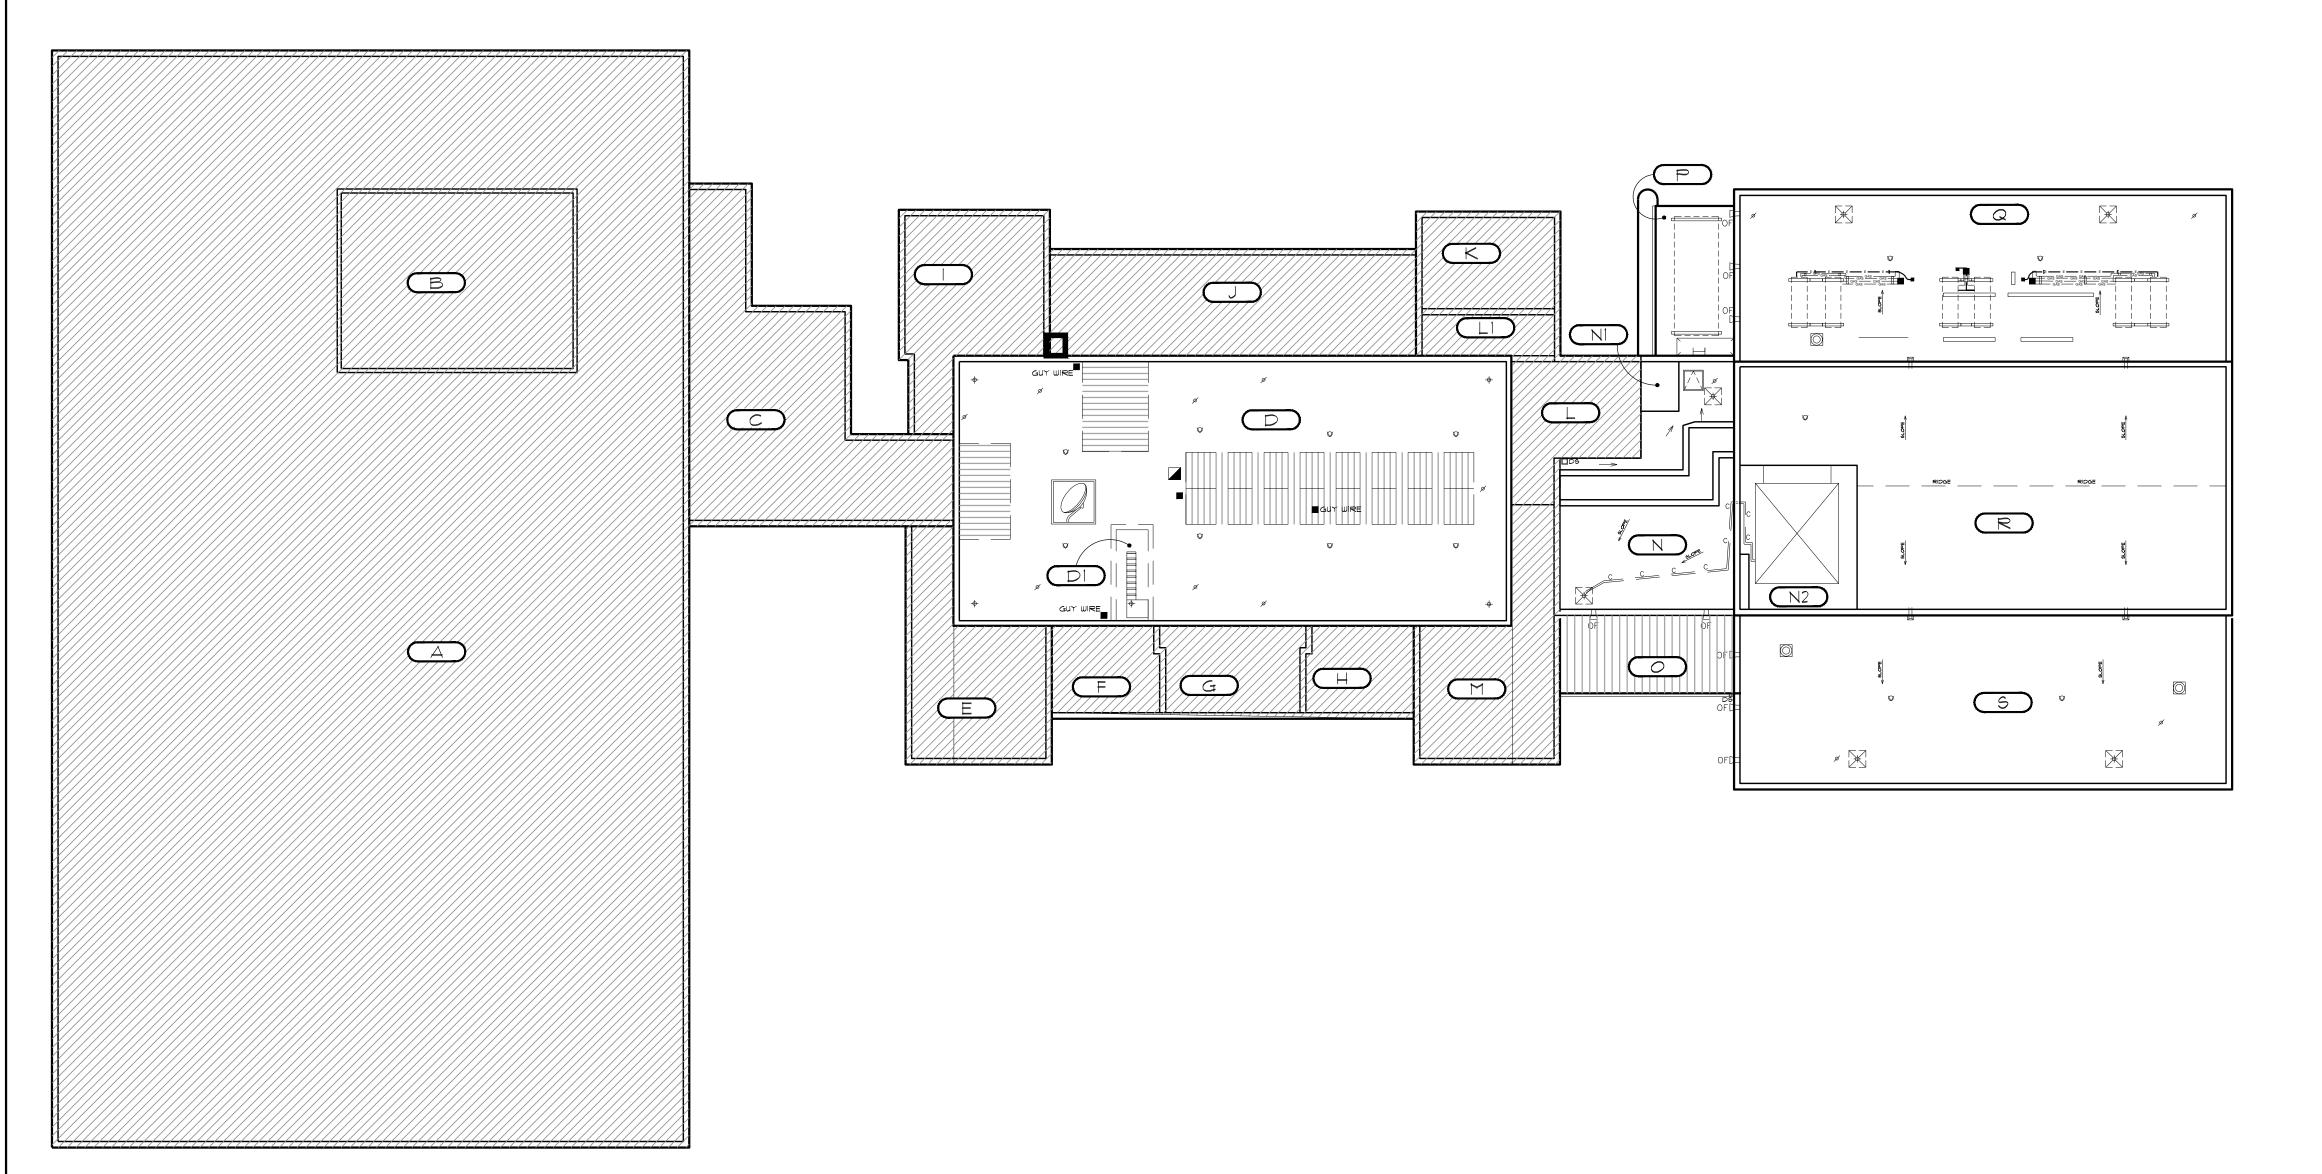

ROOF PLAN (DEMOLITION) NOTES:

- A. PROVIDE BUILDING PERMIT FROM CITY OF LONGVIEW, TX.
- B. DO NOT REMOVE MORE ROOFING THAN CAN BE MADE WATERTIGHT SHOULD INCLEMENT WEATHER ARISE. ALL ROOFING WILL BE MADE WATERTIGHT AT END OF WORK DAY. CONTRACTOR WILL MAINTAIN EMERGENCY DRY-IN MATERIALS ON SITE SUCH AS TARPS OR PLASTIC SHEETING.
- C. REMOVE EXISTING ROOF COVERINGS DOWN TO DECK. INSPECT DECK FOR DAMAGE AND DETERIORATION. NOTIFY A/E OF ANY SUSPECT DECK AREAS.
- D. DISCONNECT AND RECONNECT DESIGNATED EXISTING HYAC EQUIPMENT AS NEEDED DURING THE ROOF REPLACEMENT PROCESS. REMOVE EXISTING BASE FLASHINGS DOWN TO SUBSTRATE.
- E. REMOVE AND SALVAGE DESIGNATED EXISTING ROOFTOP EQUIPMENT IN PREPARATION FOR NEW WORK.
- F. REMOVE EXISTING METAL FLASHINGS, BASE FLASHINGS, AND COUNTERFLASHINGS IN PREPARATION FOR NEW WORK, PROPERLY DISPOSE OF WASTE IN AN APPROVED LANDFILL OR RECYCLING FACILITY.
- G. REMOVE EXISTING CURB FLASHINGS, AND TRIM. PROPERLY DISPOSE OF WASTE IN AN APPROVED LANDFILL OR RECYCLING FACILITY. PREPARE AREA TO RECEIVE NEW WORK.
- H. REMOVE EXISTING FLUE CAP TO WASTE, PROPERLY DISPOSE OF IN AN APPROVED LANDFILL OR RECYCLING FACILITY.
- REMOVE ALL UNUSED OR ABANDONED EQUIPMENT AND PENETRATIONS, REPAIR DECK TO MATCH EXISTING.
- J. REMOVE EXISTING FLASHING, BOOTS, AND MEMBRANE AT ALL PIPE
- K. ALL CONSTRUCTION RELATED DEBRIS INCLUDING TEAR OFF AND TRASH GENERATED FROM NEW WORK TO BE REMOVED AND PROPERLY DISPOSED OF IN AN APPROVED LANDFILL OR RECYCLING FACILITY.
- L. CONTRACTOR SHALL CLEAN JOB SITE DAILY AND SWEEP GROUNDS WITH A MAGNET IN ORDER TO PICK UP ALL NAILS, SCREWS, AND OTHER METALLIC OBJECTS.
- M. COORDINATE DEMOLITION WITH WORK BY OTHERS.



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COURTHOUSE - ROOFING PROJECT

COUNT

GG COUNTY COURTHOUS
AST METHVIN

REV. DATE: DESCRIPTION:

0 01/27/2017 ISSUE FOR BID SET

PROJECT NO: 1-132-1

CAD DWG FILE: AD-100 ROOF DEMO.PLAN

DRAWN BY: AA

CHECKED BY: VC


OCCUPANCY
GROUP: GROUP A


SHEET TITLE:
ROOF PLAN
(DEMOLITION AND
PREPARATION)

SHEET NO. Δ D_100





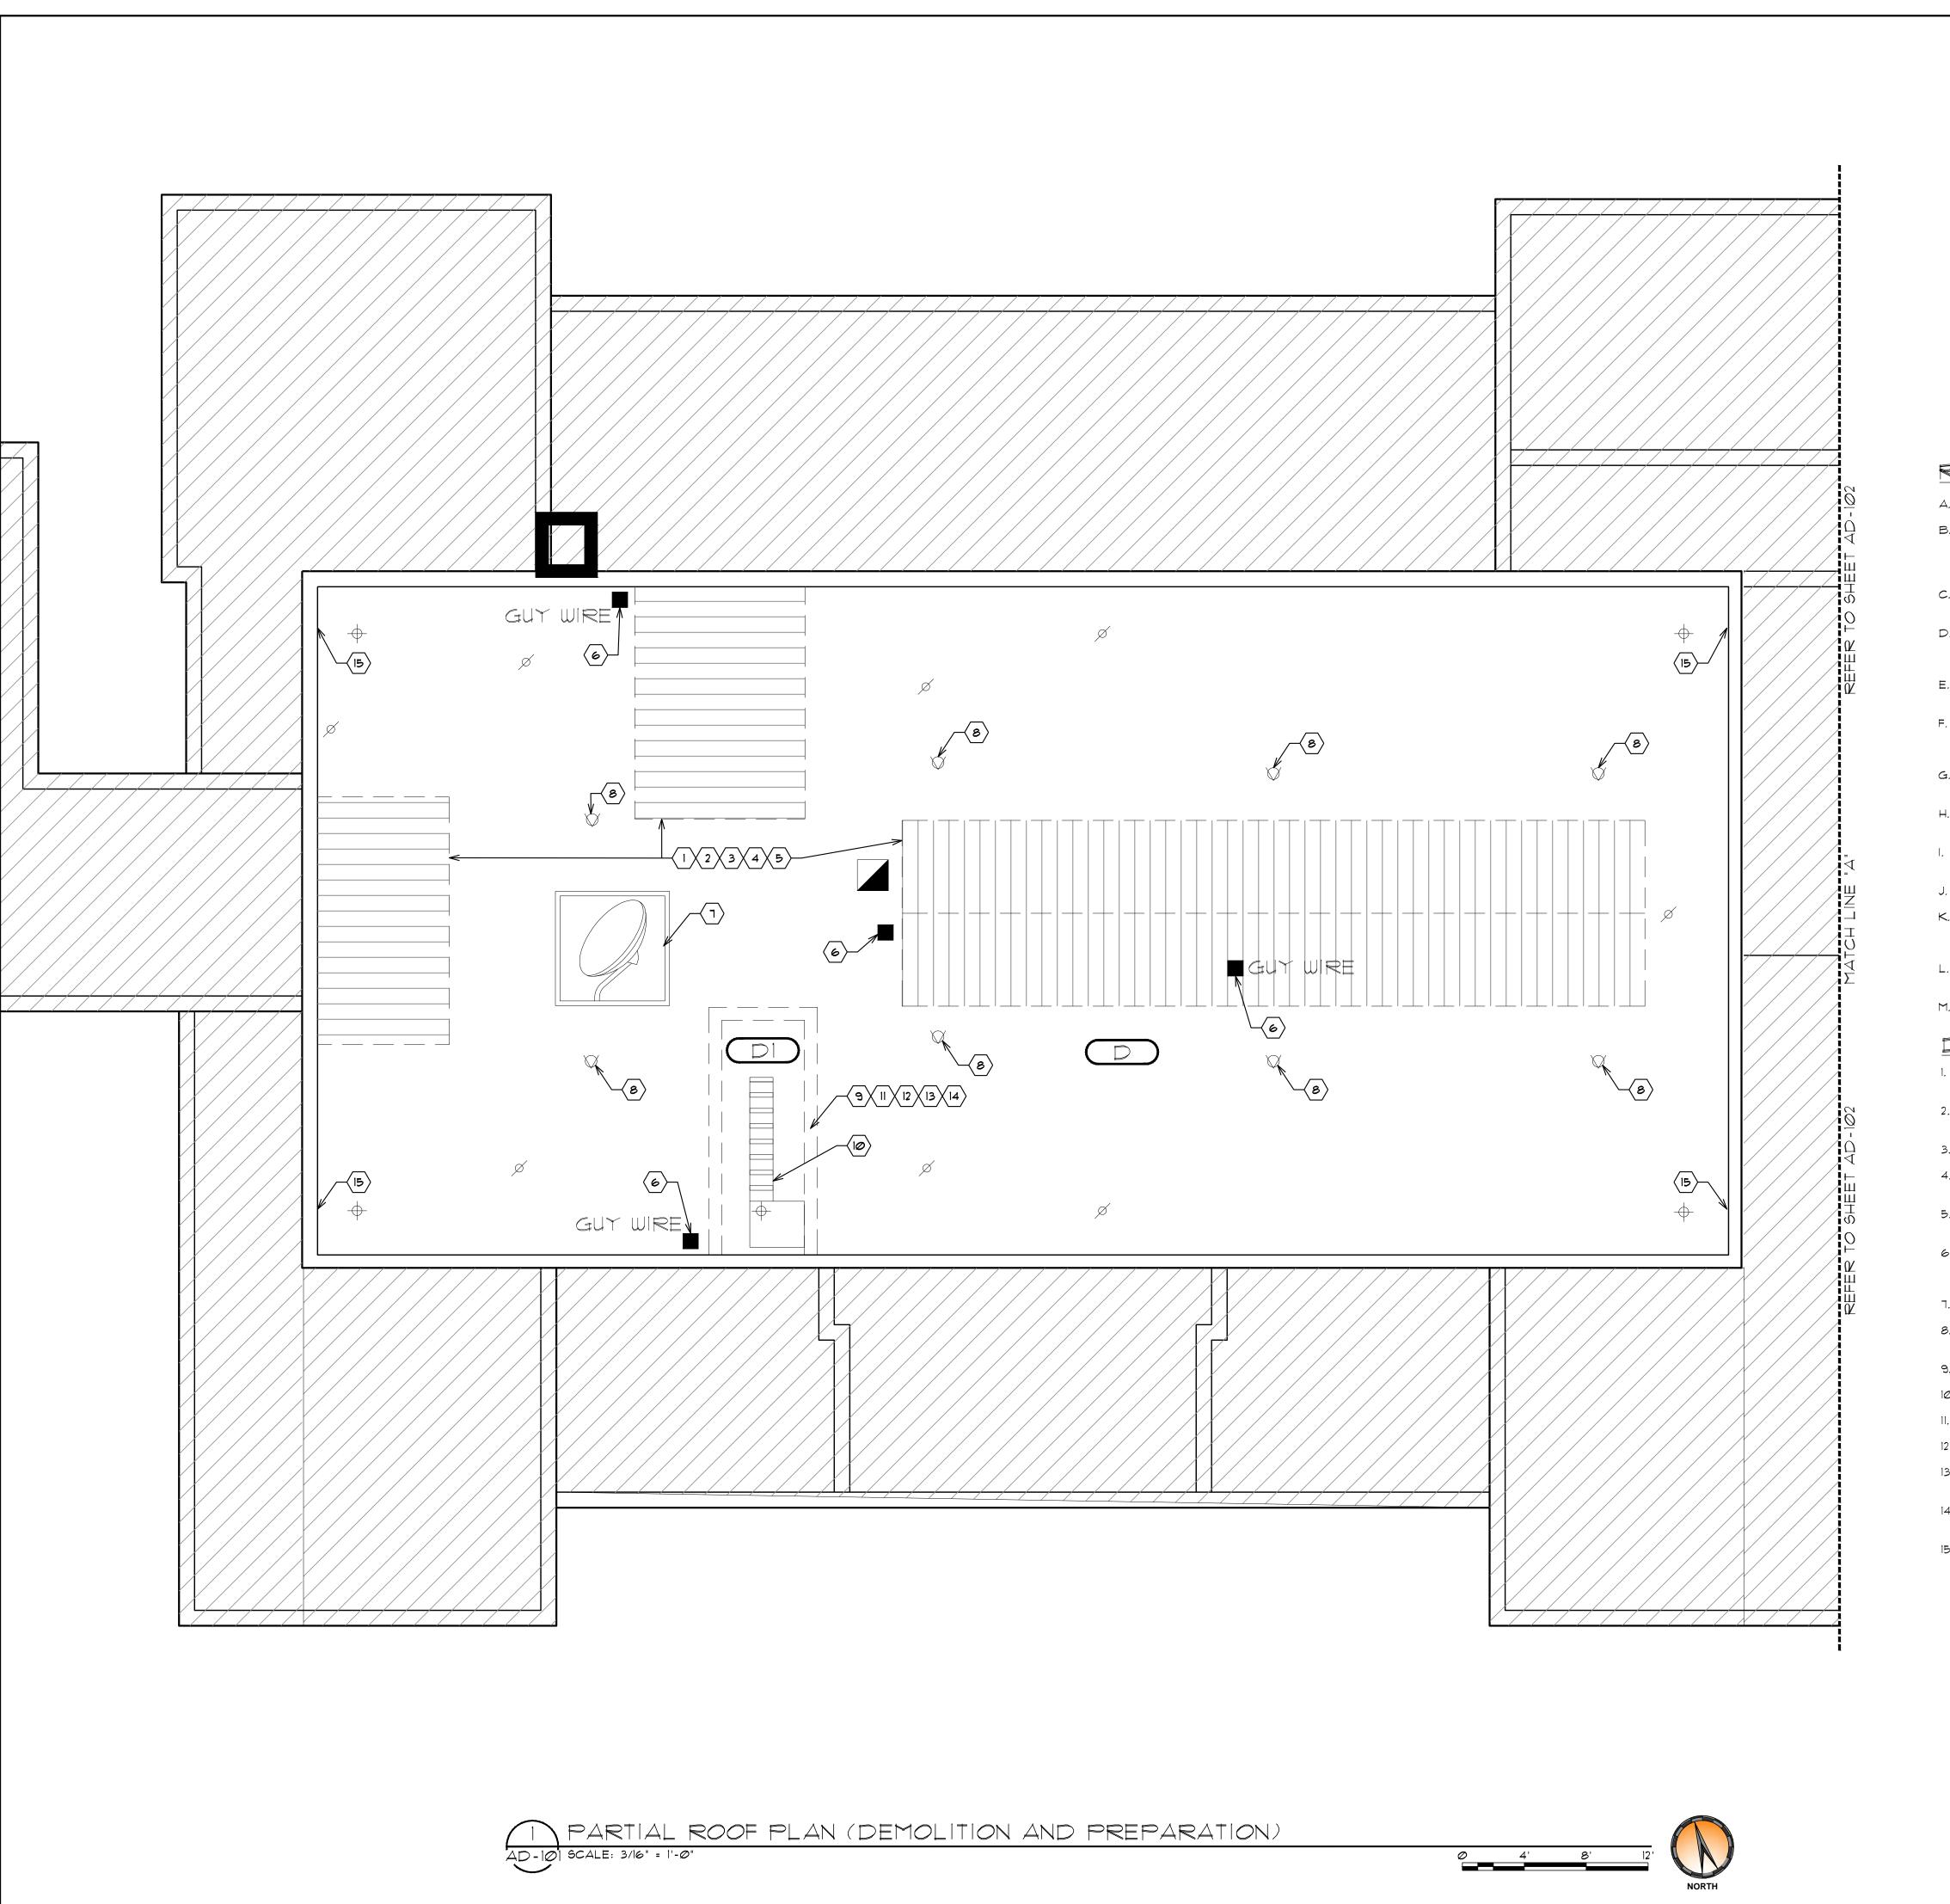

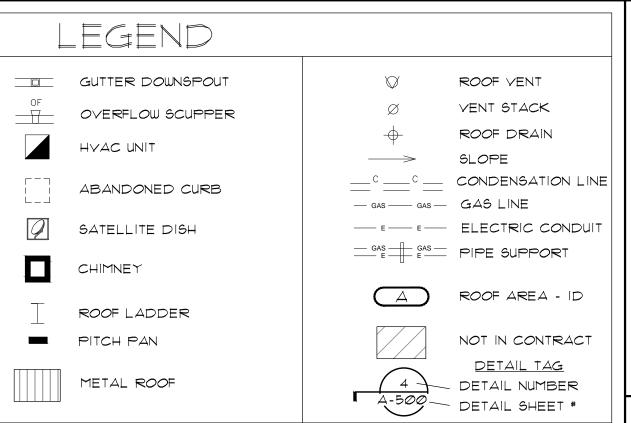


ROOF PLAN (DEMOLITION) NOTES:

- A. PROVIDE BUILDING PERMIT FROM CITY OF LONGVIEW, TX.
- B. DO NOT REMOVE MORE ROOFING THAN CAN BE MADE WATERTIGHT SHOULD INCLEMENT WEATHER ARISE. ALL ROOFING WILL BE MADE WATERTIGHT AT END OF WORK DAY. CONTRACTOR WILL MAINTAIN EMERGENCY DRY-IN MATERIALS ON SITE SUCH AS TARPS OR PLASTIC SHEETING.
- C. REMOVE EXISTING ROOF COVERINGS DOWN TO DECK. INSPECT DECK FOR DAMAGE AND DETERIORATION. NOTIFY A/E OF ANY SUSPECT DECK AREAS.
- D. DISCONNECT AND RECONNECT DESIGNATED EXISTING HVAC EQUIPMENT AS NEEDED DURING THE ROOF REPLACEMENT PROCESS. REMOVE EXISTING BASE FLASHINGS DOWN TO SUBSTRATE.
- E. REMOVE AND SALVAGE DESIGNATED EXISTING ROOFTOP EQUIPMENT IN PREPARATION FOR NEW WORK.
- F. REMOVE EXISTING METAL FLASHINGS, BASE FLASHINGS, AND COUNTERFLASHINGS IN PREPARATION FOR NEW WORK, PROPERLY DISPOSE OF WASTE IN AN APPROVED LANDFILL OR RECYCLING FACILITY.
- G. REMOVE EXISTING CURB FLASHINGS, AND TRIM. PROPERLY DISPOSE OF WASTE IN AN APPROVED LANDFILL OR RECYCLING FACILITY. PREPARE AREA TO RECEIVE NEW WORK.
- H. REMOVE EXISTING FLUE CAP TO WASTE, PROPERLY DISPOSE OF IN AN APPROVED LANDFILL OR RECYCLING FACILITY.
- I. REMOVE ALL UNUSED OR ABANDONED EQUIPMENT AND PENETRATIONS, REPAIR DECK TO MATCH EXISTING.
- J. REMOVE EXISTING FLASHING, BOOTS, AND MEMBRANE AT ALL PIPE PENETRATIONS.
- K. ALL CONSTRUCTION RELATED DEBRIS INCLUDING TEAR OFF AND TRASH GENERATED FROM NEW WORK TO BE REMOVED AND PROPERLY DISPOSED OF IN AN APPROVED LANDFILL OR RECYCLING FACILITY.
- L. CONTRACTOR SHALL CLEAN JOB SITE DAILY AND SWEEP GROUNDS WITH A MAGNET IN ORDER TO PICK UP ALL NAILS, SCREWS, AND OTHER METALLIC OBJECTS.
- M. COORDINATE DEMOLITION WITH WORK BY OTHERS.

DEMOLITION ROOF PLAN KEYED NOTES:

- I. REMOVE METAL ROOFS ON THREE WELL AREAS AND ALL STRUCTURAL SUPPORTS FOR METAL ROOFS, KEEPING METAL BAR NETWORK IN PLACE.
- 2. REMOVE BRICK CURB / KNEE WALL CONSTRUCTION TO STRUCTURAL BLOCK WALLS,
- KEEPING METAL BAR NETWORK IN PLACE.
- 3. INSTALL FLAT METAL PANELS OVER BAR NETWORK, AS SPECIFIED.
- 4. INSTALL NEW INSULATION AND/OR COVER BOARD AS APPROPRIATE TO BRING BACK TO LEVEL WITH SURROUNDING DECK AS SPECIFIED.
- 5. INSTALL NEW TEMPORARY ROOF OVER INSULATION/COVERBOARD ASSEMBLY, TYING INTO EXISTING CONCRETE DECK.
- 6. REMOVE ANTENNA TOWER (ALTERNATE TO LEAVE IN PLACE). REMOVE EXISTING GUY WIRE ANCHORS & PITCH PANS, INSTALL NEW GUY WIRE ANCHORS AS DETAILED HEREIN, IF TOWER REMAINS
- 1. REMOVE SATELLITE DISH AND SUPPORTS.
- 8. REMOVE VENTS OVER HOLES THROUGH CONCRETE DECK. COVER HOLES THROUGH DECK WITH SHEET METAL PANELS.
- 9. REMOVE BRICK CURB / KNEE WALLS SURROUNDING WELL OVER ROOF AREA D-1.
- 10.REMOVE METAL STAIRCASE FROM ROOF AREA D-1.
- II. INSTALL NEW STRUCTURAL DECK SUPPORTS FOR NEW METAL DECK OVER ROOF AREA D-1.
- 12. INSTALL NEW METAL DECK OVER ROOF AREA D-1.
- 13. INSTALL NEW INSULATION AND/OR COVERBOARD AS APPROPRIATE TO BRING BACK TO LEVEL WITH SURROUNDING DECK AS SPECIFIED.
- 14. INSTALL NEW TEMPORARY ROOF OVER INSULATION/COVERBOARD, TYING INTO EXISTING CONCRETE DECK.
- 15. CUT NEW OPENINGS FOR OVERFLOW SCUPPERS THROUGH PARAPET WALLS AT EACH DRAIN LOCATION WHERE NONE CURRENTLY EXIST.

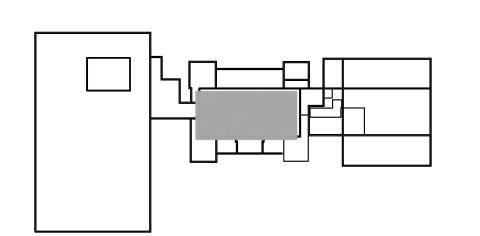







roof consulting & design

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COPPELL, TX 75019

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ROOFING PROJEC

REPLACEMENT AT GG COUNTY COURTHOUS SAST METHVIN

REV. DATE: DESCRIPTION:

0 01/27/2017 ISSUE FOR BID SET

PROJECT NO: 1-132-1

CAD DWG FILE: AD-100 ROOF DEMO.PLAN


DRAWN BY: AA


CHECKED BY: VC

OCCUPANCY
GROUP: GROUP A

ROOF PLAN
(DEMOLITION AND PREPARATION)

AD-101

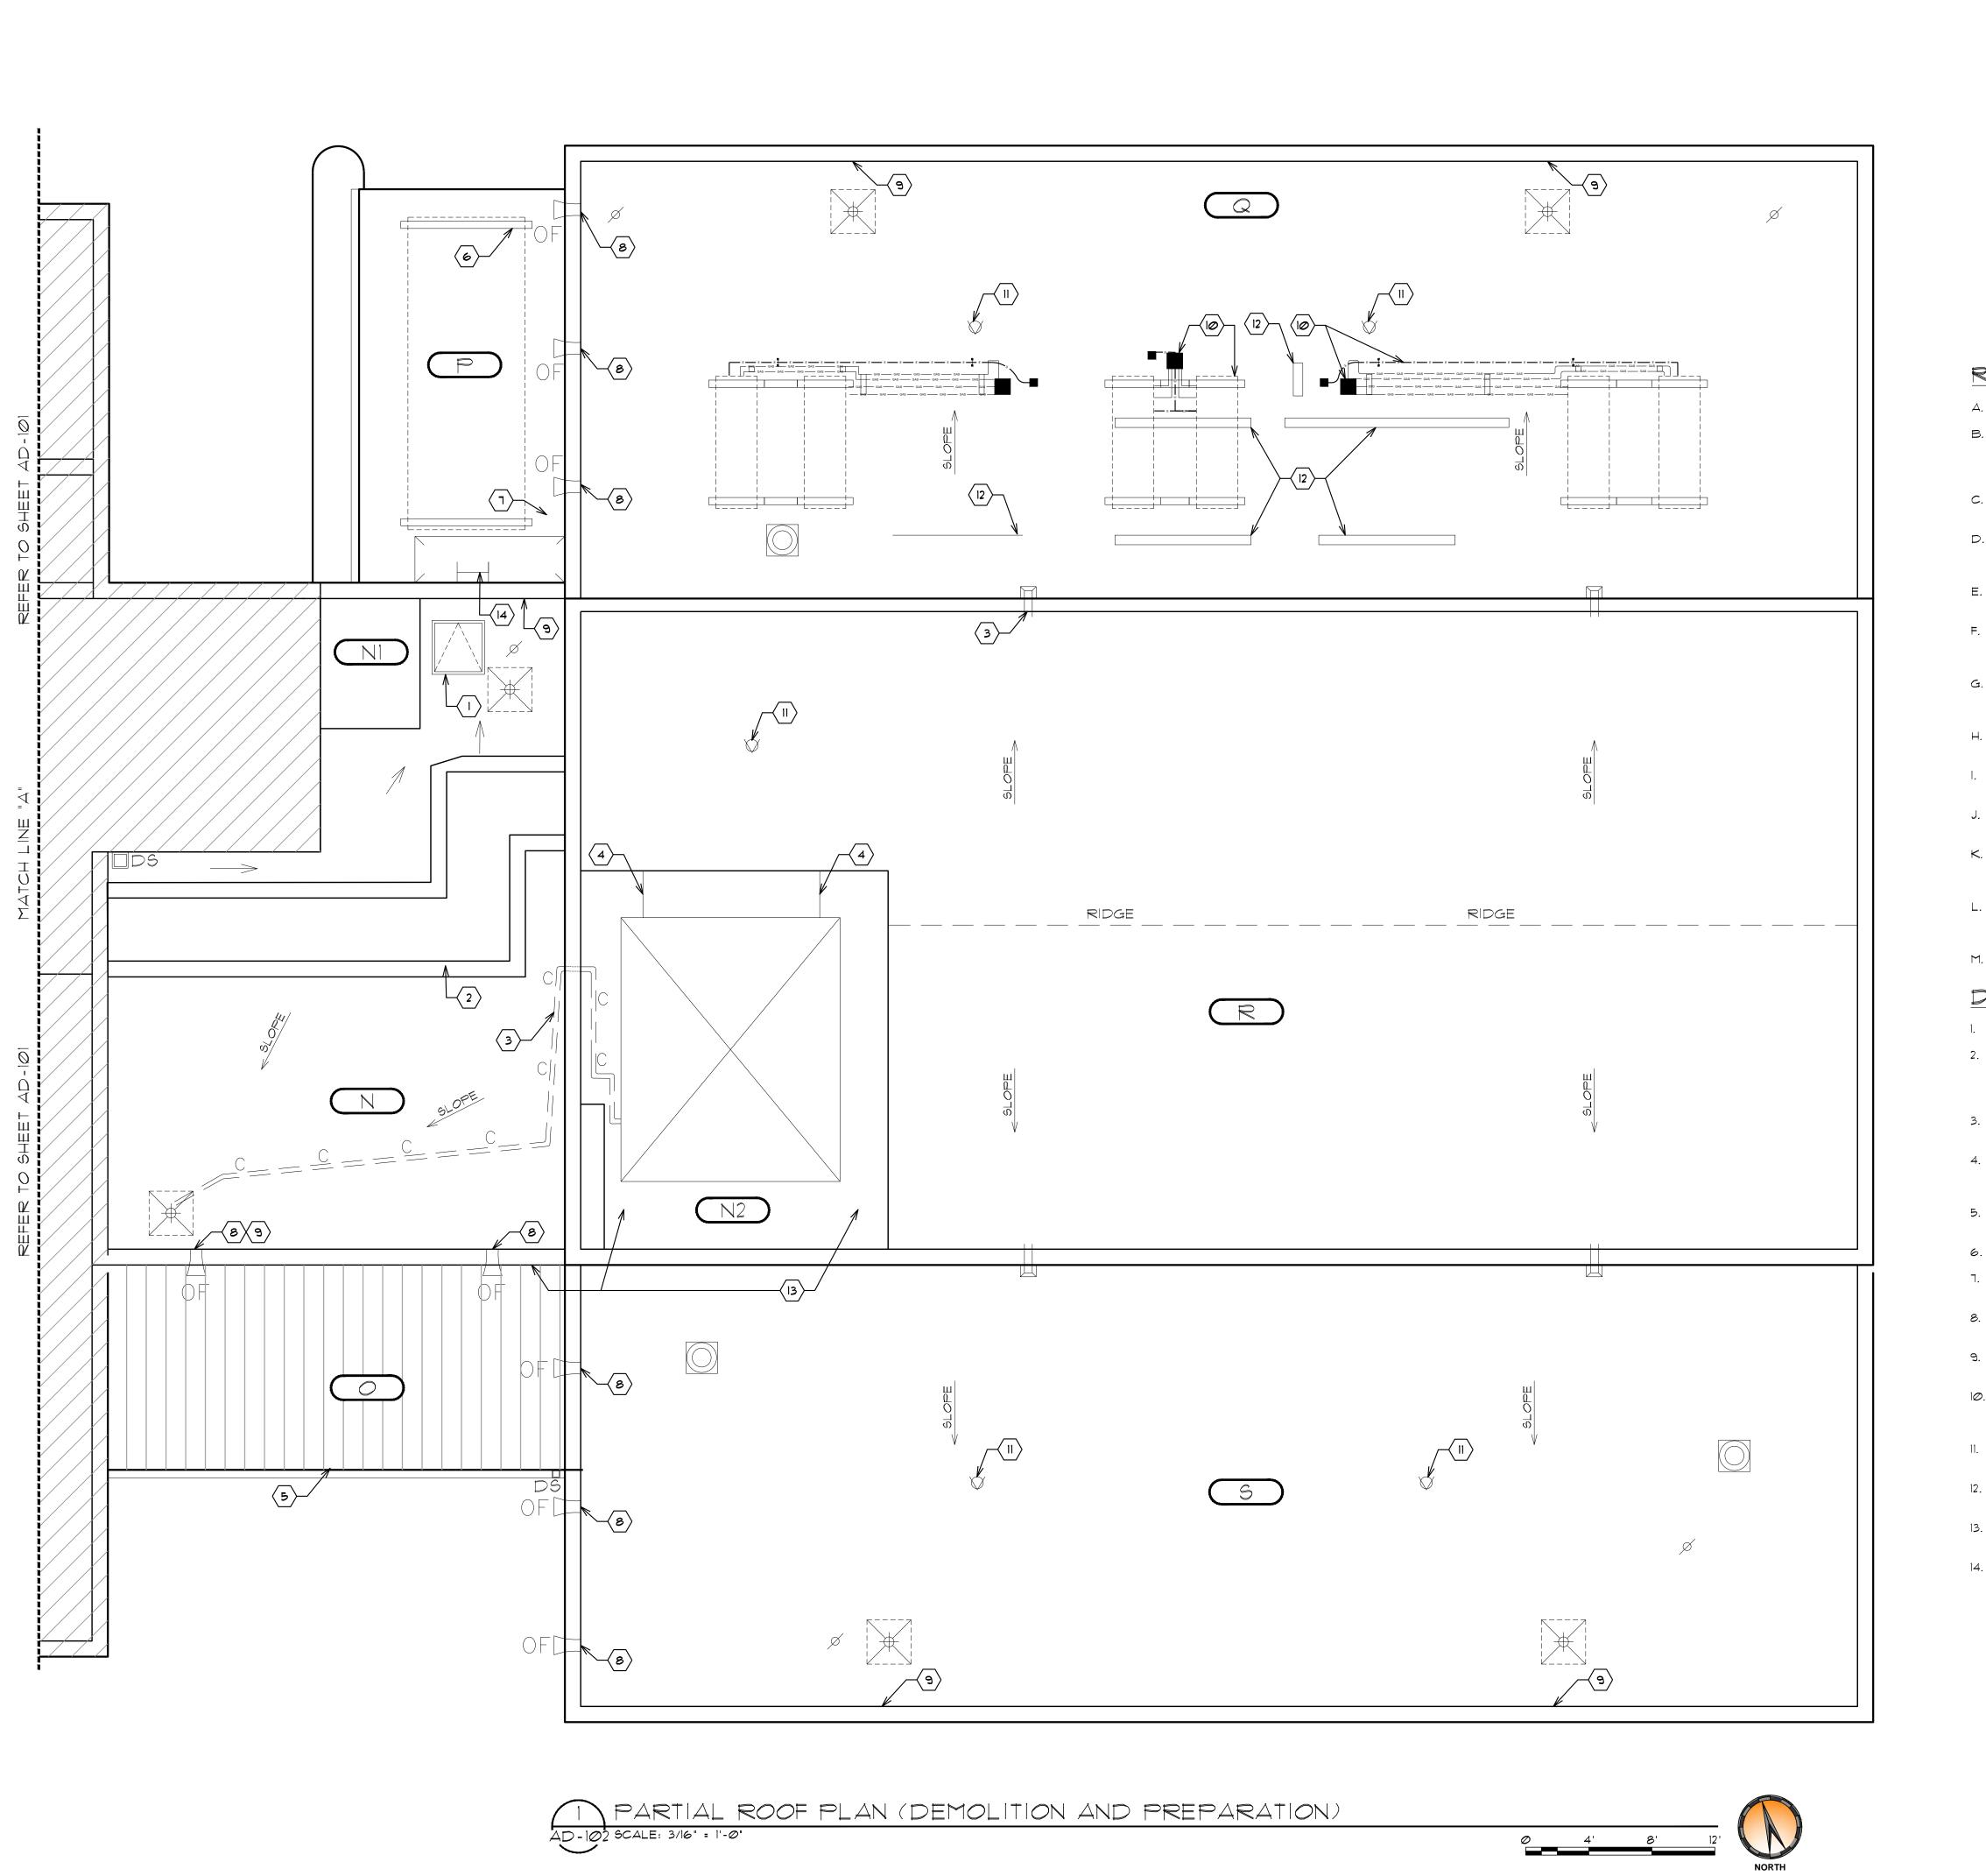

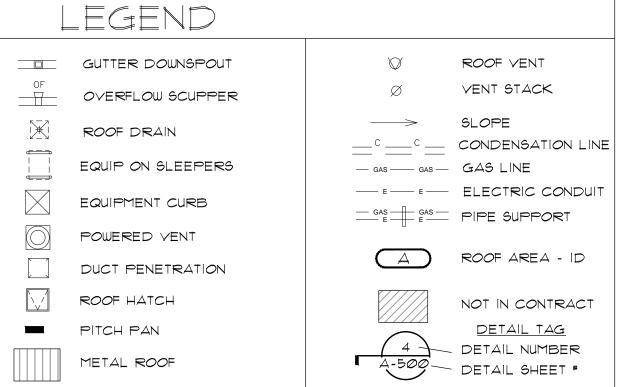


ROOF PLAN (DEMOLITION) NOTES:

- A. PROVIDE BUILDING PERMIT FROM CITY OF LONGVIEW, TX.
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- C. REMOVE EXISTING ROOF COVERINGS DOWN TO DECK, INSPECT DECK FOR DAMAGE AND DETERIORATION. NOTIFY A/E OF ANY SUSPECT DECK AREAS.
- D. DISCONNECT AND RECONNECT DESIGNATED EXISTING HYAC EQUIPMENT AS NEEDED DURING THE ROOF REPLACEMENT PROCESS. REMOVE EXISTING BASE FLASHINGS DOWN TO SUBSTRATE.
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- K. ALL CONSTRUCTION RELATED DEBRIS INCLUDING TEAR OFF AND TRASH GENERATED FROM NEW WORK TO BE REMOVED AND PROPERLY DISPOSED OF IN AN APPROVED LANDFILL OR RECYCLING FACILITY.
- L. CONTRACTOR SHALL CLEAN JOB SITE DAILY AND SWEEP GROUNDS WITH A MAGNET IN ORDER TO PICK UP ALL NAILS, SCREWS, AND OTHER METALLIC
- M. COORDINATE DEMOLITION WITH WORK BY OTHERS.

DEMOLITION ROOF PLAN KEYED NOTES:

- I. EXISTING ROOF HATCH/CURB WILL BE RAISED TO NEW LEVEL AS SPECIFIED.
- 2. LEAVE EXISTING FOIL SURFACED ROOF MEMBRANE AND FOIL SURFACE IN-PLACE AS A TEMPORARY ROOF UNTIL NEW LIGHTWEIGHT INSULATING CONCRETE HAS BEEN PLACED, AND IMMEDIATELY PRIOR TO INSTALLATION OF NEW ROOF MEMBRANE
- 3. REMOVE AND DISCARD PVC CONDENSATE LINE. RE-ROUTE CONDENSATE LINE TO DRAIN LINE TO BE INSTALLED AT AREA N-2.
- 4. INSTALL NEW CURB AND PLYWOOD HOUSING OVER HVAC ROOF AND WALL CONNECTIONS TO PREPARE FOR INSTALLATION OF NEW MEMBRANE AN FLUID APPLIED FLASHING.
- 5. REMOVE EXISTING ROOF EDGE AND GUTTER IN PREPARATION FOR NEW EDGE AND GUTTER.
- 6. MECHANICALLY ANCHOR FLANGES OF EXISTING METAL SLEEPER CURBS.
- 1. INSTALL NEW DRAIN. ROUTE LINE UNDERNEATH ROOF DECK TO OUTSIDE WALL AND GROUNDS.
- 8. REMOVE EXISTING ROUND PIPES USED AS OVERFLOW SCUPPERS AND FILL OPENING WITH STONE BRICKS TO MATCH EXISTING STONE WORK.
- 9. CUT NEW OPENINGS FOR OVERFLOW SCUPPERS THROUGH PARAPET WALLS AT EACH EXISTING DRAIN LOCATION.
- 10. DISCONNECT AND REMOVE ALL HVAC EQUIPMENT, SUPPORTS AND PITCH PAN INSTALL NEW CURB TO PROVIDE FOR ACCESS TO SUPPLY LINES FOR FUTURE HYAC
- II. REMOVE VENTS OVER HOLES THROUGH GYPSUM DECK. COVER HOLES THROUGH DECK WITH SHEET METAL PANELS.
- 12. UNUSED EQUIPMENT SUPPORTS TO BE REMOVED TO WASTE. REPAIR AREA AND PREPARE TO RECEIVE NEW WORK.
- 13. INSTALL NEW DRAINS, ROUTE LINE UNDERNEATH AREA N2 & N THROUGH OUTSIDE WALL AND DOWNSPOUT ONTO AREA O.
- 14. REMOVE EXISTING LADDER AND INSTALL NEW ONE AS SPECIFIED.

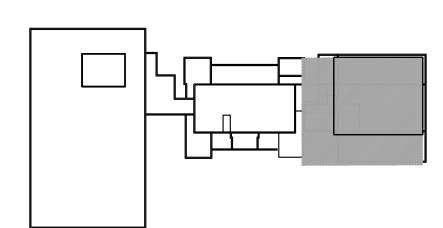







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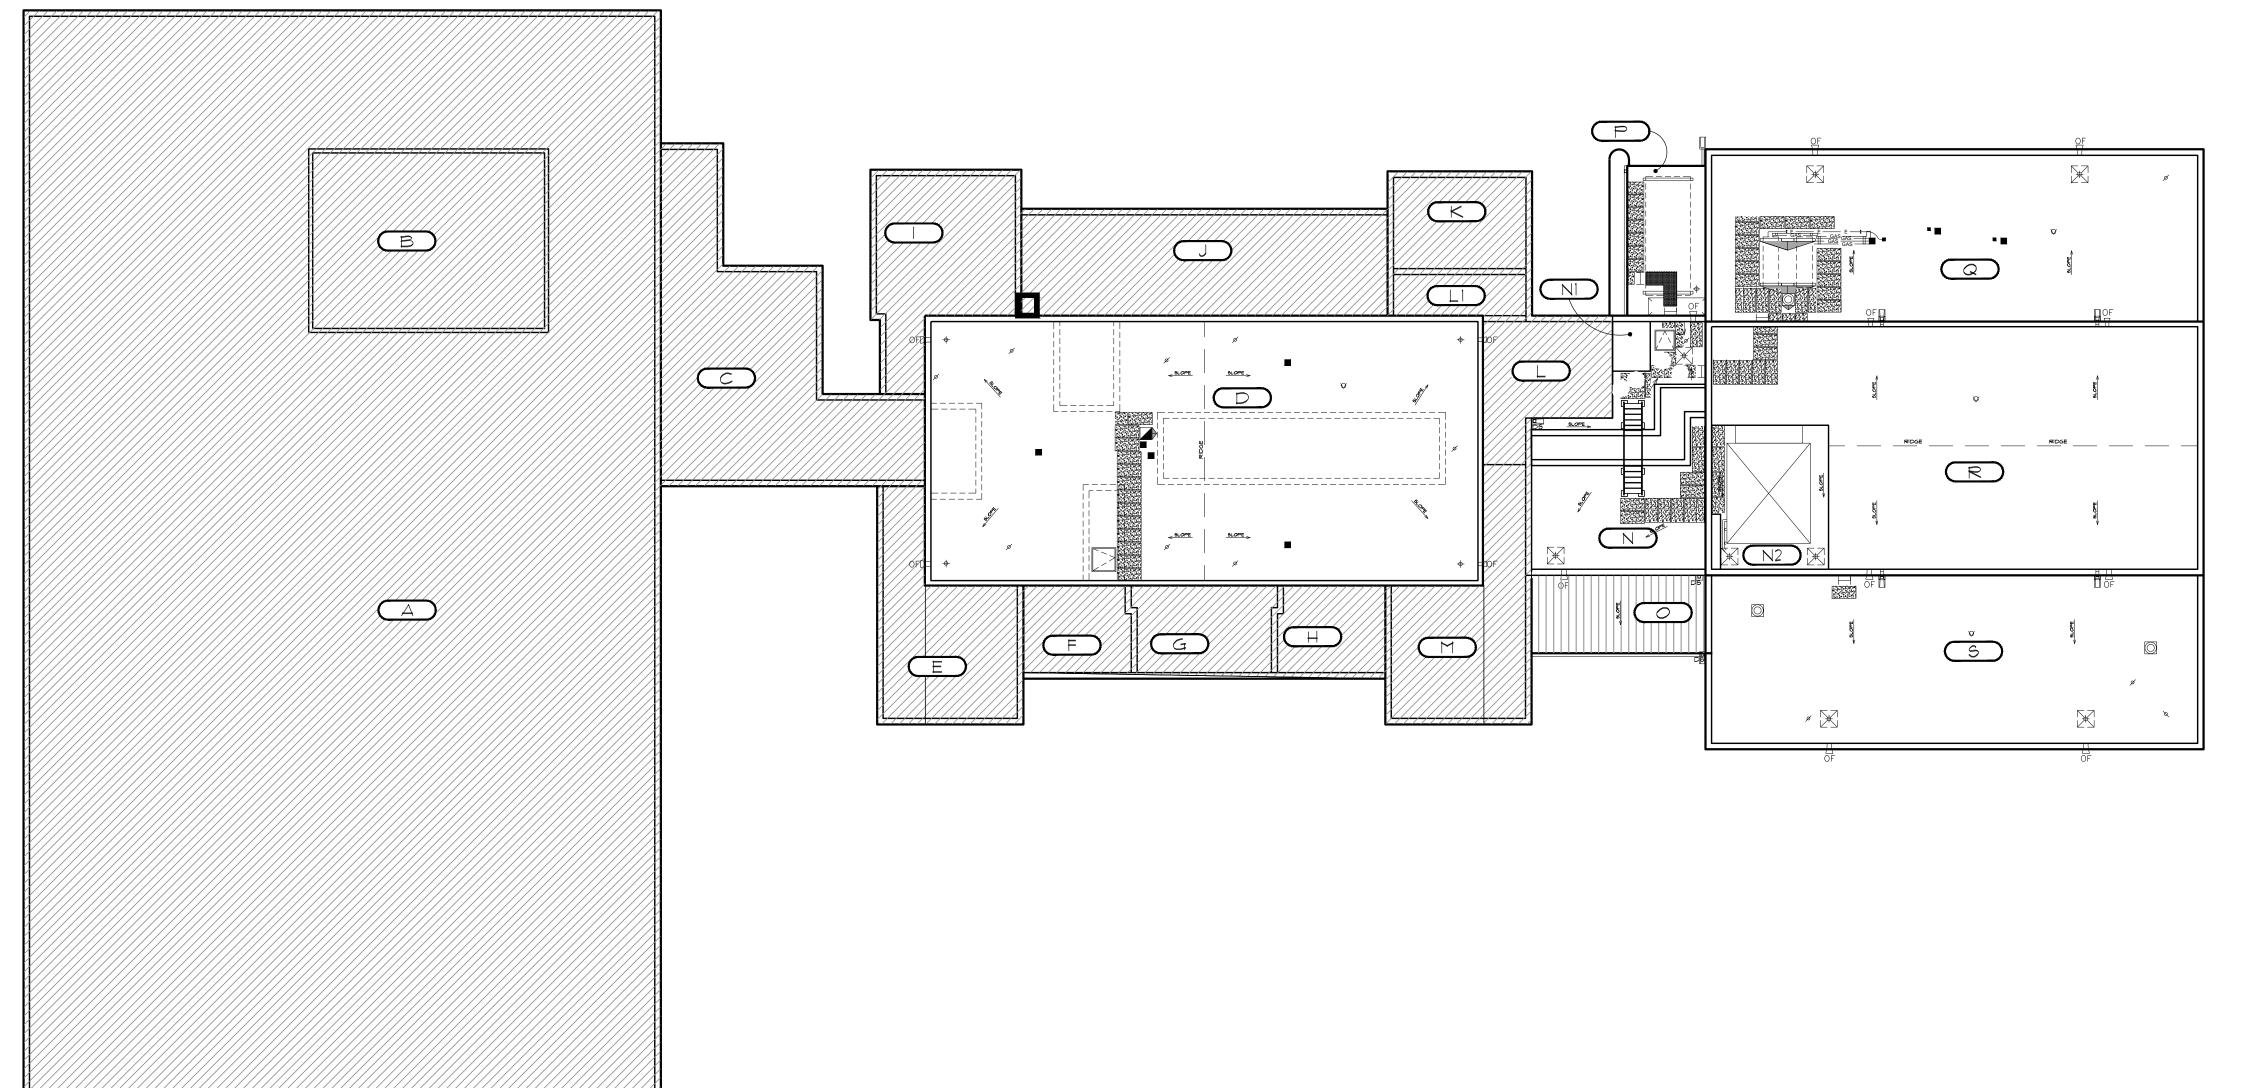
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REV. DATE: DESCRIPTION: 0 01/27/2017 ISSUE FOR BID SET

PROJECT NO: 1-132-1 CAD DWG FILE: AD-100 ROOF DEMO.PLAN DRAWN BY: CHECKED BY: OCCUPANCY


GROUP A

SHEET TITLE: ROOF PLAN (DEMOLITION AND PREPARATION)







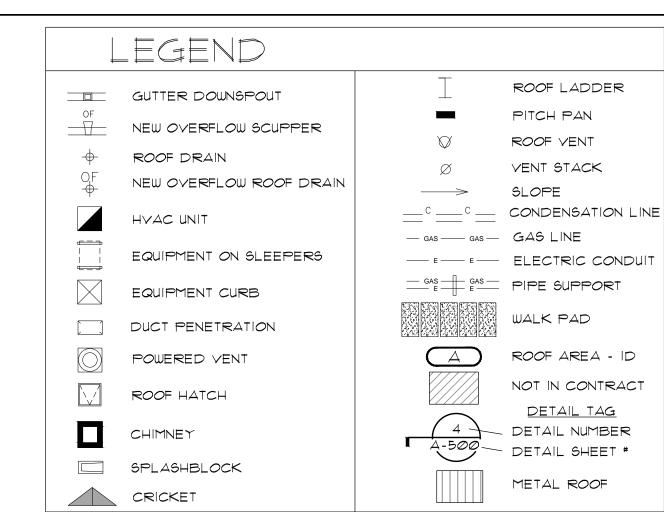

GENERAL PROJECT NOTES:

A. PROVIDE BUILDING PERMIT FROM CITY OF LONGVIEW, TX.

AND MATERIALS IN OWNER DESIGNATED AREAS ONLY.

- B. ALL DIMENSIONS ARE APPROXIMATE. CONTRACTOR TO FIELD VERIFY.
- C. FURNISH OWNER WITH 2 YEAR CONTRACTOR WARRANTY ON ALL WORK PERFORMED.
- D. CONTRACTOR SHALL COORDINATE WORK EFFORTS TO COMPLETE THE WORK WITHIN THE CONTRACT PERIOD. WORK SHALL BE STAGED AND COORDINATED SUCH THAT WORK PROGRESS SHALL NOT REQUIRE MATERIAL OR FOOT TRAFFIC TO TRAVERSE DIRECTLY OVER NEWLY INSTALLED ROOFING. CONTRACTOR SHALL STAGE EQUIPMENT
- E. INSTALL NEW LIGHTWEIGHT INSULATING CONCRETE AS SHOWN INCLUDING CRICKETS WHERE SHOWN WITH POSITIVE SLOPE FOR DRAINAGE ON THE UPHILL SIDE OF ALL CURBS 2 FEET OR GREATER. CRICKET SLOPE TO BE 2X FINISHED ROOF SLOPE.
- F. ABSOLUTELY NO PONDING WATER (AS DEFINED BY NRCA) WILL BE ALLOWED.
- G. CONTRACTOR SHALL BE RESPONSIBLE FOR HER/HIS CONSTRUCTION MEANS AND METHODS. CONTRACTOR IS SOLELY RESPONSIBLE FOR HER/HIS SAFETY MEASURES TO PROTECT EMPLOYEES, PATRONS, VISITORS, ETC. WORK SHALL BE PROTECTED FROM AND NOT INTERFERE WITH OWNERS DAILY OPERATIONS UNLESS COORDINATED WITH SUCH.
- H. CONTRACTOR SHALL WALK SITE PRIOR TO COMMENCEMENT OF ANY WORK AND PROVIDE PHOTOGRAPHIC DOCUMENTATION OF EXISTING CONDITIONS. CONTRACTOR SHALL VERIFY WORKING CONDITION OF ALL MECHANICAL, ELECTRICAL, AND PLUMBING EQUIPMENT. PROVIDE WRITTEN DOCUMENTATION OF CONDITION TO OWNER PRIOR TO COMMENCEMENT OF WORK.
- I. CONTRACTOR SHALL BE RESPONSIBLE TO REPAIR OR REPLACE DAMAGE TO ANY BUILDING, SITE COMPONENT, OR ADJACENT PROPERTY CAUSED BY CONSTRUCTION TO THE SATISFACTION OF THE OWNER.
- J. CONTRACTOR SHALL CONFORM TO ALL APPLICABLE FEDERAL, STATE, LOCAL OR OTHER APPLICABLE REGULATORY AGENCY BUILDING CODES, LAWS, RULES AND REGULATIONS. WORK DETAILED ON THESE PLANS SHALL BE COMPLETED ACCORDING TO THE PROJECT DOCUMENTS. IF CONFLICT ARISES BETWEEN CODE AND PROJECT DOCUMENTS, CONTRACTOR SHALL IMMEDIATELY NOTIFY THE A/E FOR CLARIFICATION.
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- M. ALL WORK PERFORMED BY THE CONTRACTOR AND HER/HIS SUBCONTRACTORS SHALL CONFORM TO THE PROJECT DOCUMENTS. ANY WORK DEEMED DEFECTIVE OR UNACCEPTABLE BY THE OWNER OR A/E SHALL BE REPAIRED OR REPLACED TO THE SATISFACTION OF THE OWNER.
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- O. ALL GAS PIPING AND ELECTRICAL CONDUIT ROUTING/CONNECTION TO ROOF TOP UNITS SHALL COMPLY WITH CURRENT MECHANICAL AND ELECTRICAL CODE REQUIREMENTS AS REQUIRED. (INCLUDING FLEX CONDUIT CONNECTIONS TO ROOF TOP UNITS)
- P. CONTRACTOR SHALL BE RESPONSIBLE FOR DELIVERY, RECEIVING, AND PROPER STORAGE OF MATERIALS AND EQUIPMENT AT THE SITE, CONTRACTOR SHALL INSPECT EQUIPMENT AND MATERIALS, REJECTING ANY DAMAGED OR DEFECTIVE MATERIALS OR EQUIPMENT, MATERIALS DEEMED DEFECTIVE OR UNACCEPTABLE BY THE A/E SHALL BE REMOVED FROM THE SITE WITHIN TWENTY-FOUR (24) HOURS.
- Q. ALL ROOFING MATERIAL SHOWN SHALL BE CONSIDERED NEW PRODUCT UNLESS NOTED OTHERWISE.
- R. PROVIDE ALL NEW FLASHINGS OF A TYPE AND MATERIAL AS REQUIRED BY ROOFING MEMBRANE MANUFACTURER FOR REQUIRED 20 YEAR WARRANTY.
- 5. ALL BASE FLASHING HEIGHTS MUST MEET A MINIMUM 8 INCHES HEIGHT. SOME CURBS, METAL SIDING, COUNTERFLASHING AND EQUIPMENT MAY NEED TO BE RAISED TO ALLOW FOR A MINIMUM 8 INCH BASE FLASHING HEIGHT. CONTRACTOR TO REMOVE AND STORE EQUIPMENT FOR REINSTALLATION AS NECESSARY. CONTRACTOR WILL RAISE CURBS, EXTEND DUCTWORK, AND EXTEND PIPES AS NECESSARY TO PROVIDE 8 INCH MINIMUM BASE FLASHING
- T. INSTALL NEW WALKPADS WHERE REQUIRED, AND AT ALL ACCESS POINTS, PATHWAYS, AND AROUND ALL SERVICEABLE EQUIPMENT, AS SPECIFIED AND AS SHOWN HEREIN.
- U. PROVIDE ALL NEW COUNTERFLASHINGS, TERMINATION BARS, METAL PENETRATION FLASHINGS AS SHOWN ON DETAILS HEREIN, AND OF A TYPE AND MATERIAL AS REQUIRED BY ROOFING MEMBRANE MANUFACTURER FOR REQUIRED 20 YEAR
- V. CONTRACTOR SHALL CLEAN JOB SITE DAILY AND SWEEP GROUNDS WITH A MAGNET IN ORDER TO PICK UP ALL NAILS, SCREWS, AND OTHER METALLIC OBJECTS.



roof consulting & design

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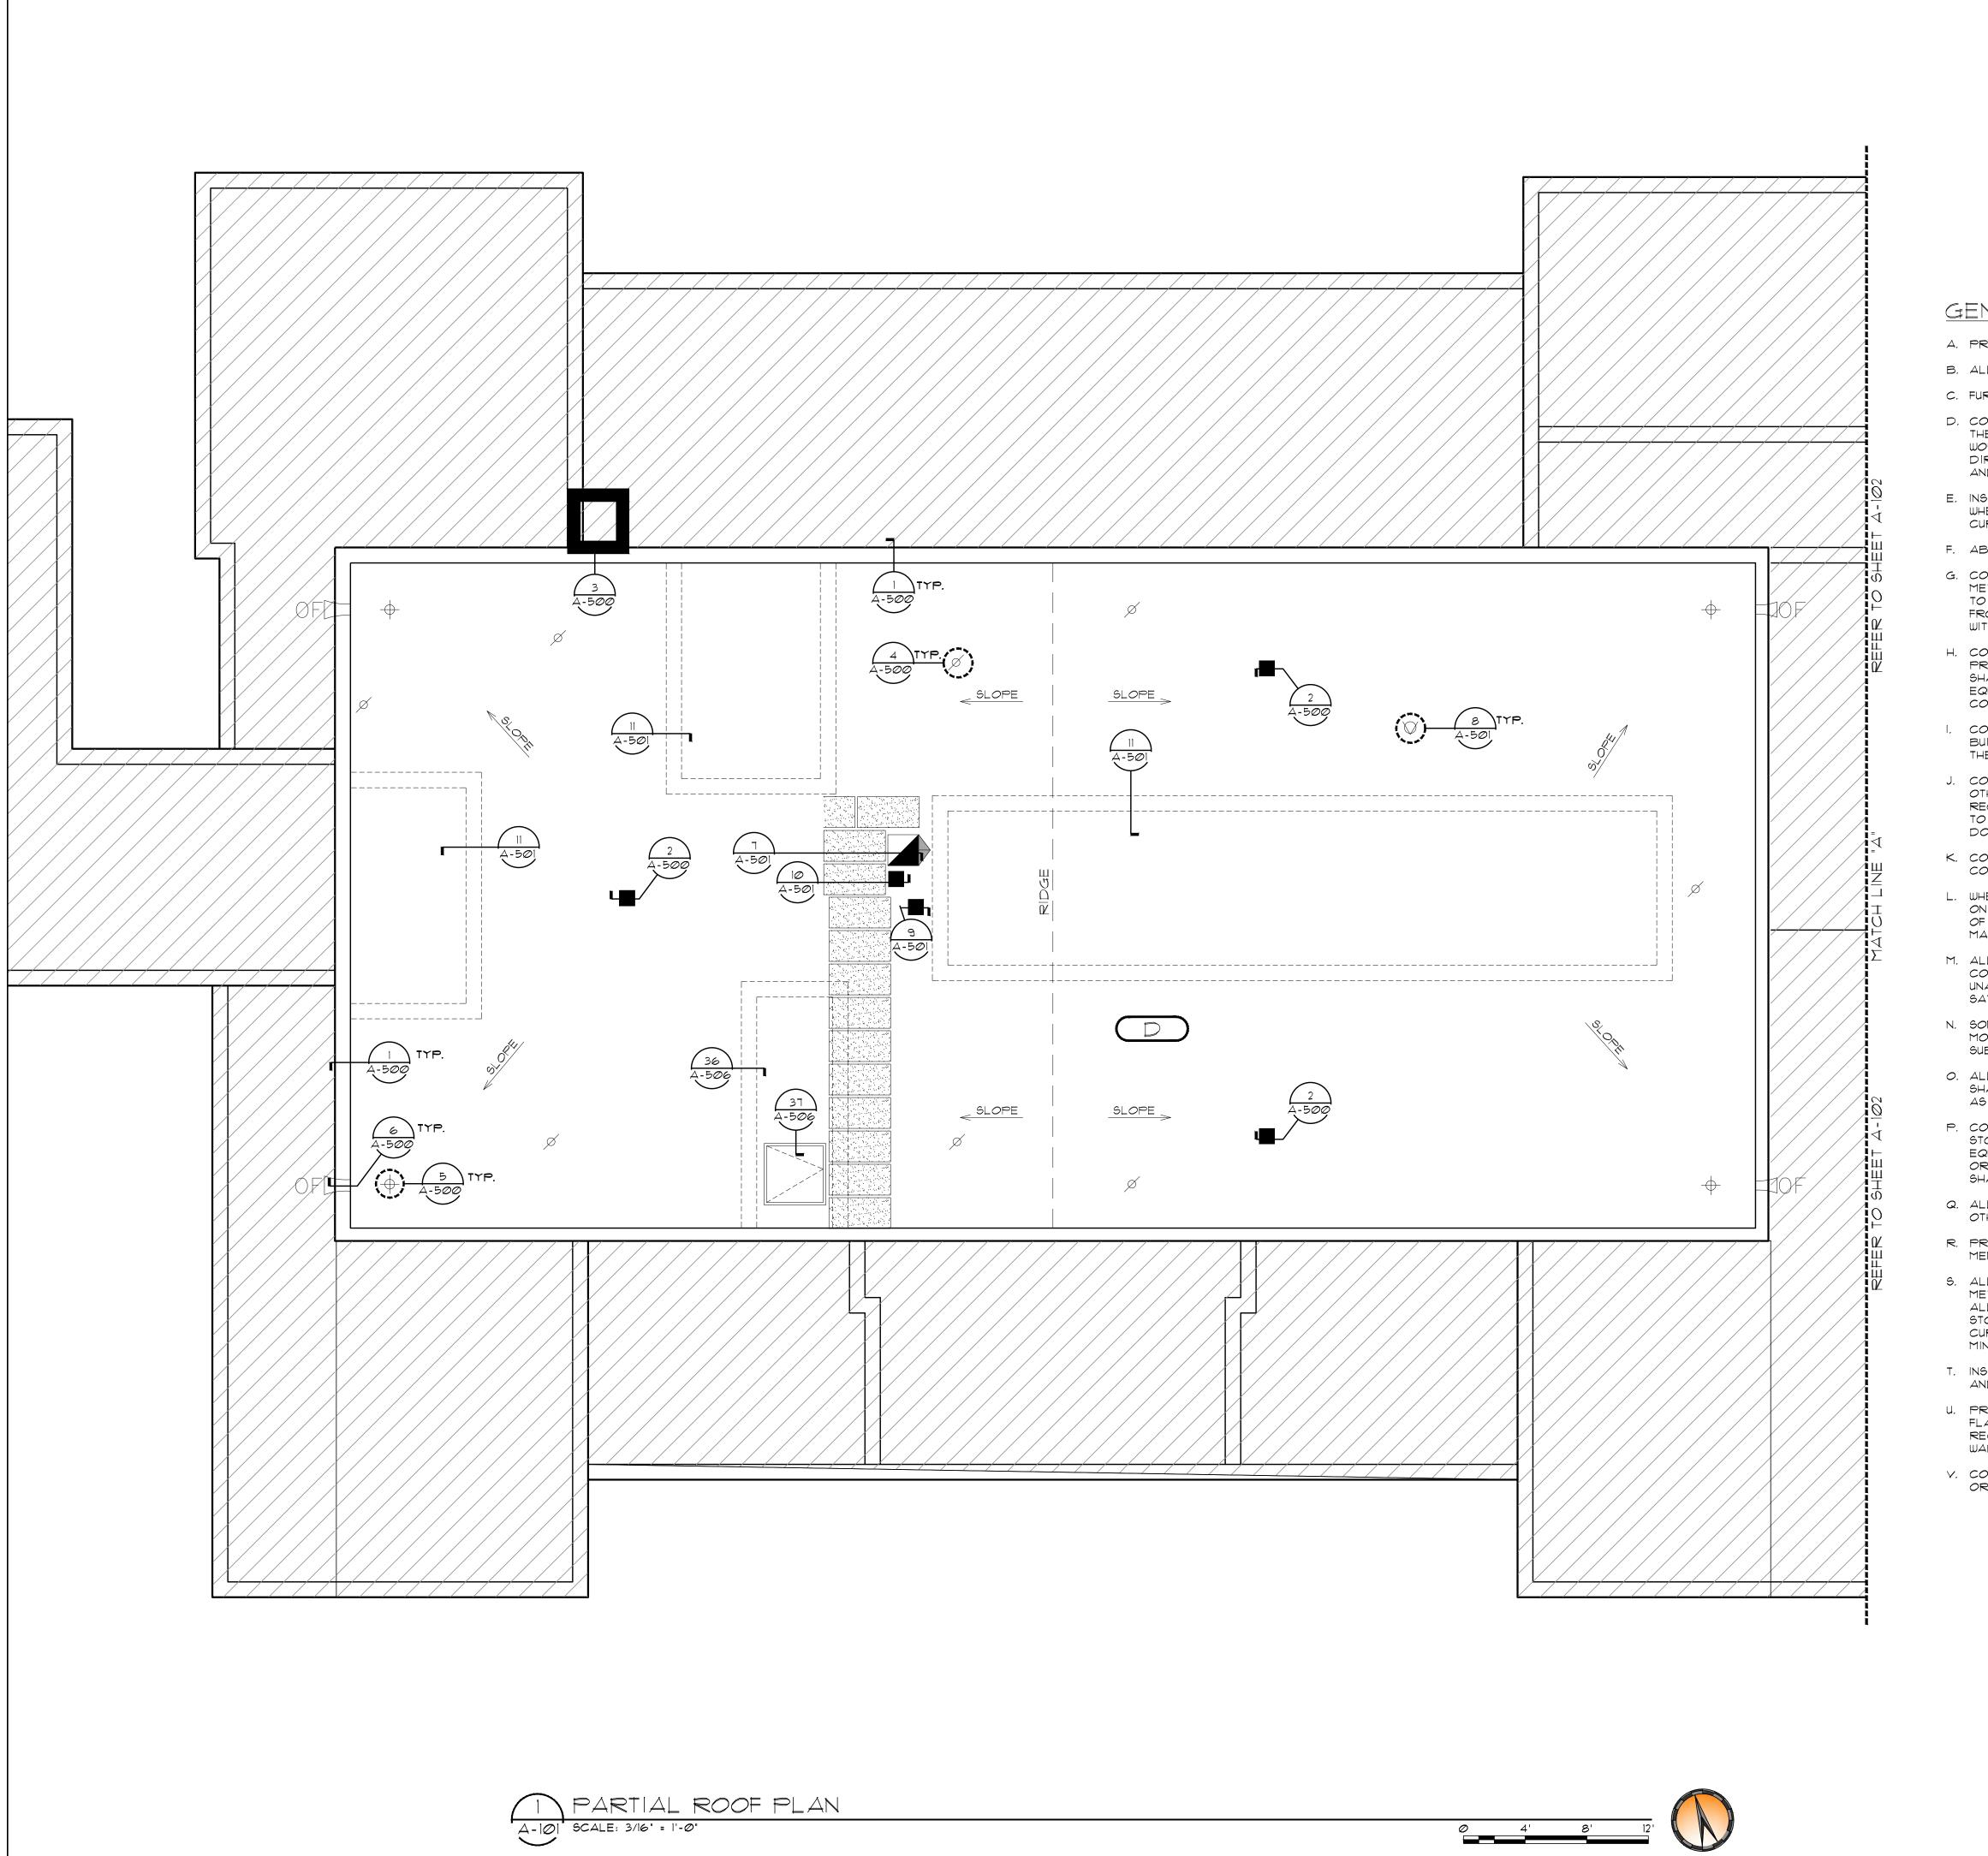
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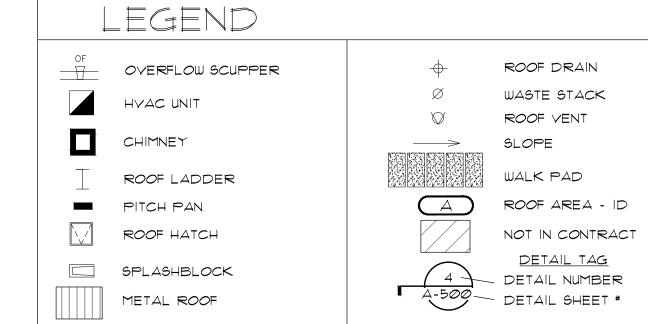
GREGG (PHASE 1)
BID#2017
A ROOF REPLA
GREGG (GREGG (101)

DESCRIPTION: 0 01/27/2017 ISSUE FOR BID SET

PROJECT NO: 1-132-1 CAD DWG FILE: A-100 SCOPE PLAN DRAWN BY: CHECKED BY: OCCUPANCY GROUP:


SHEET TITLE: SCOPE PLAN





GENERAL PROJECT NOTES:

- A. PROVIDE BUILDING PERMIT FROM CITY OF LONGVIEW, TX.
- B. ALL DIMENSIONS ARE APPROXIMATE. CONTRACTOR TO FIELD VERIFY.
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UNTY - COURTHOUSE - ROOFING PROJEC

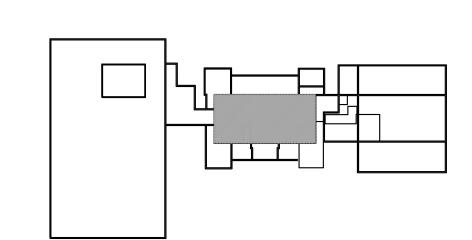PHASE 1
BID#2017-703
A ROOF REPLACEMENT AT
GREGG COUNTY

REV. DATE: DESCRIPTION:

0 01/27/2017 ISSUE FOR BID SET

PROJECT NO: 1-132-1

CAD DWG FILE: A-100 ROOF PLAN

DRAWN BY: AA


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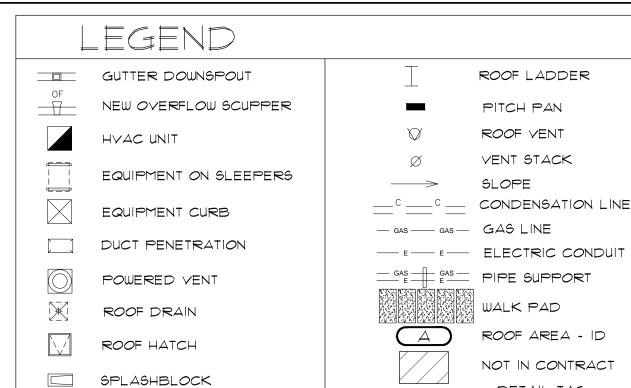
OCCUPANCY

ROOF PLAN
AREAS: D & D1

SHEET NO.

GROUP:



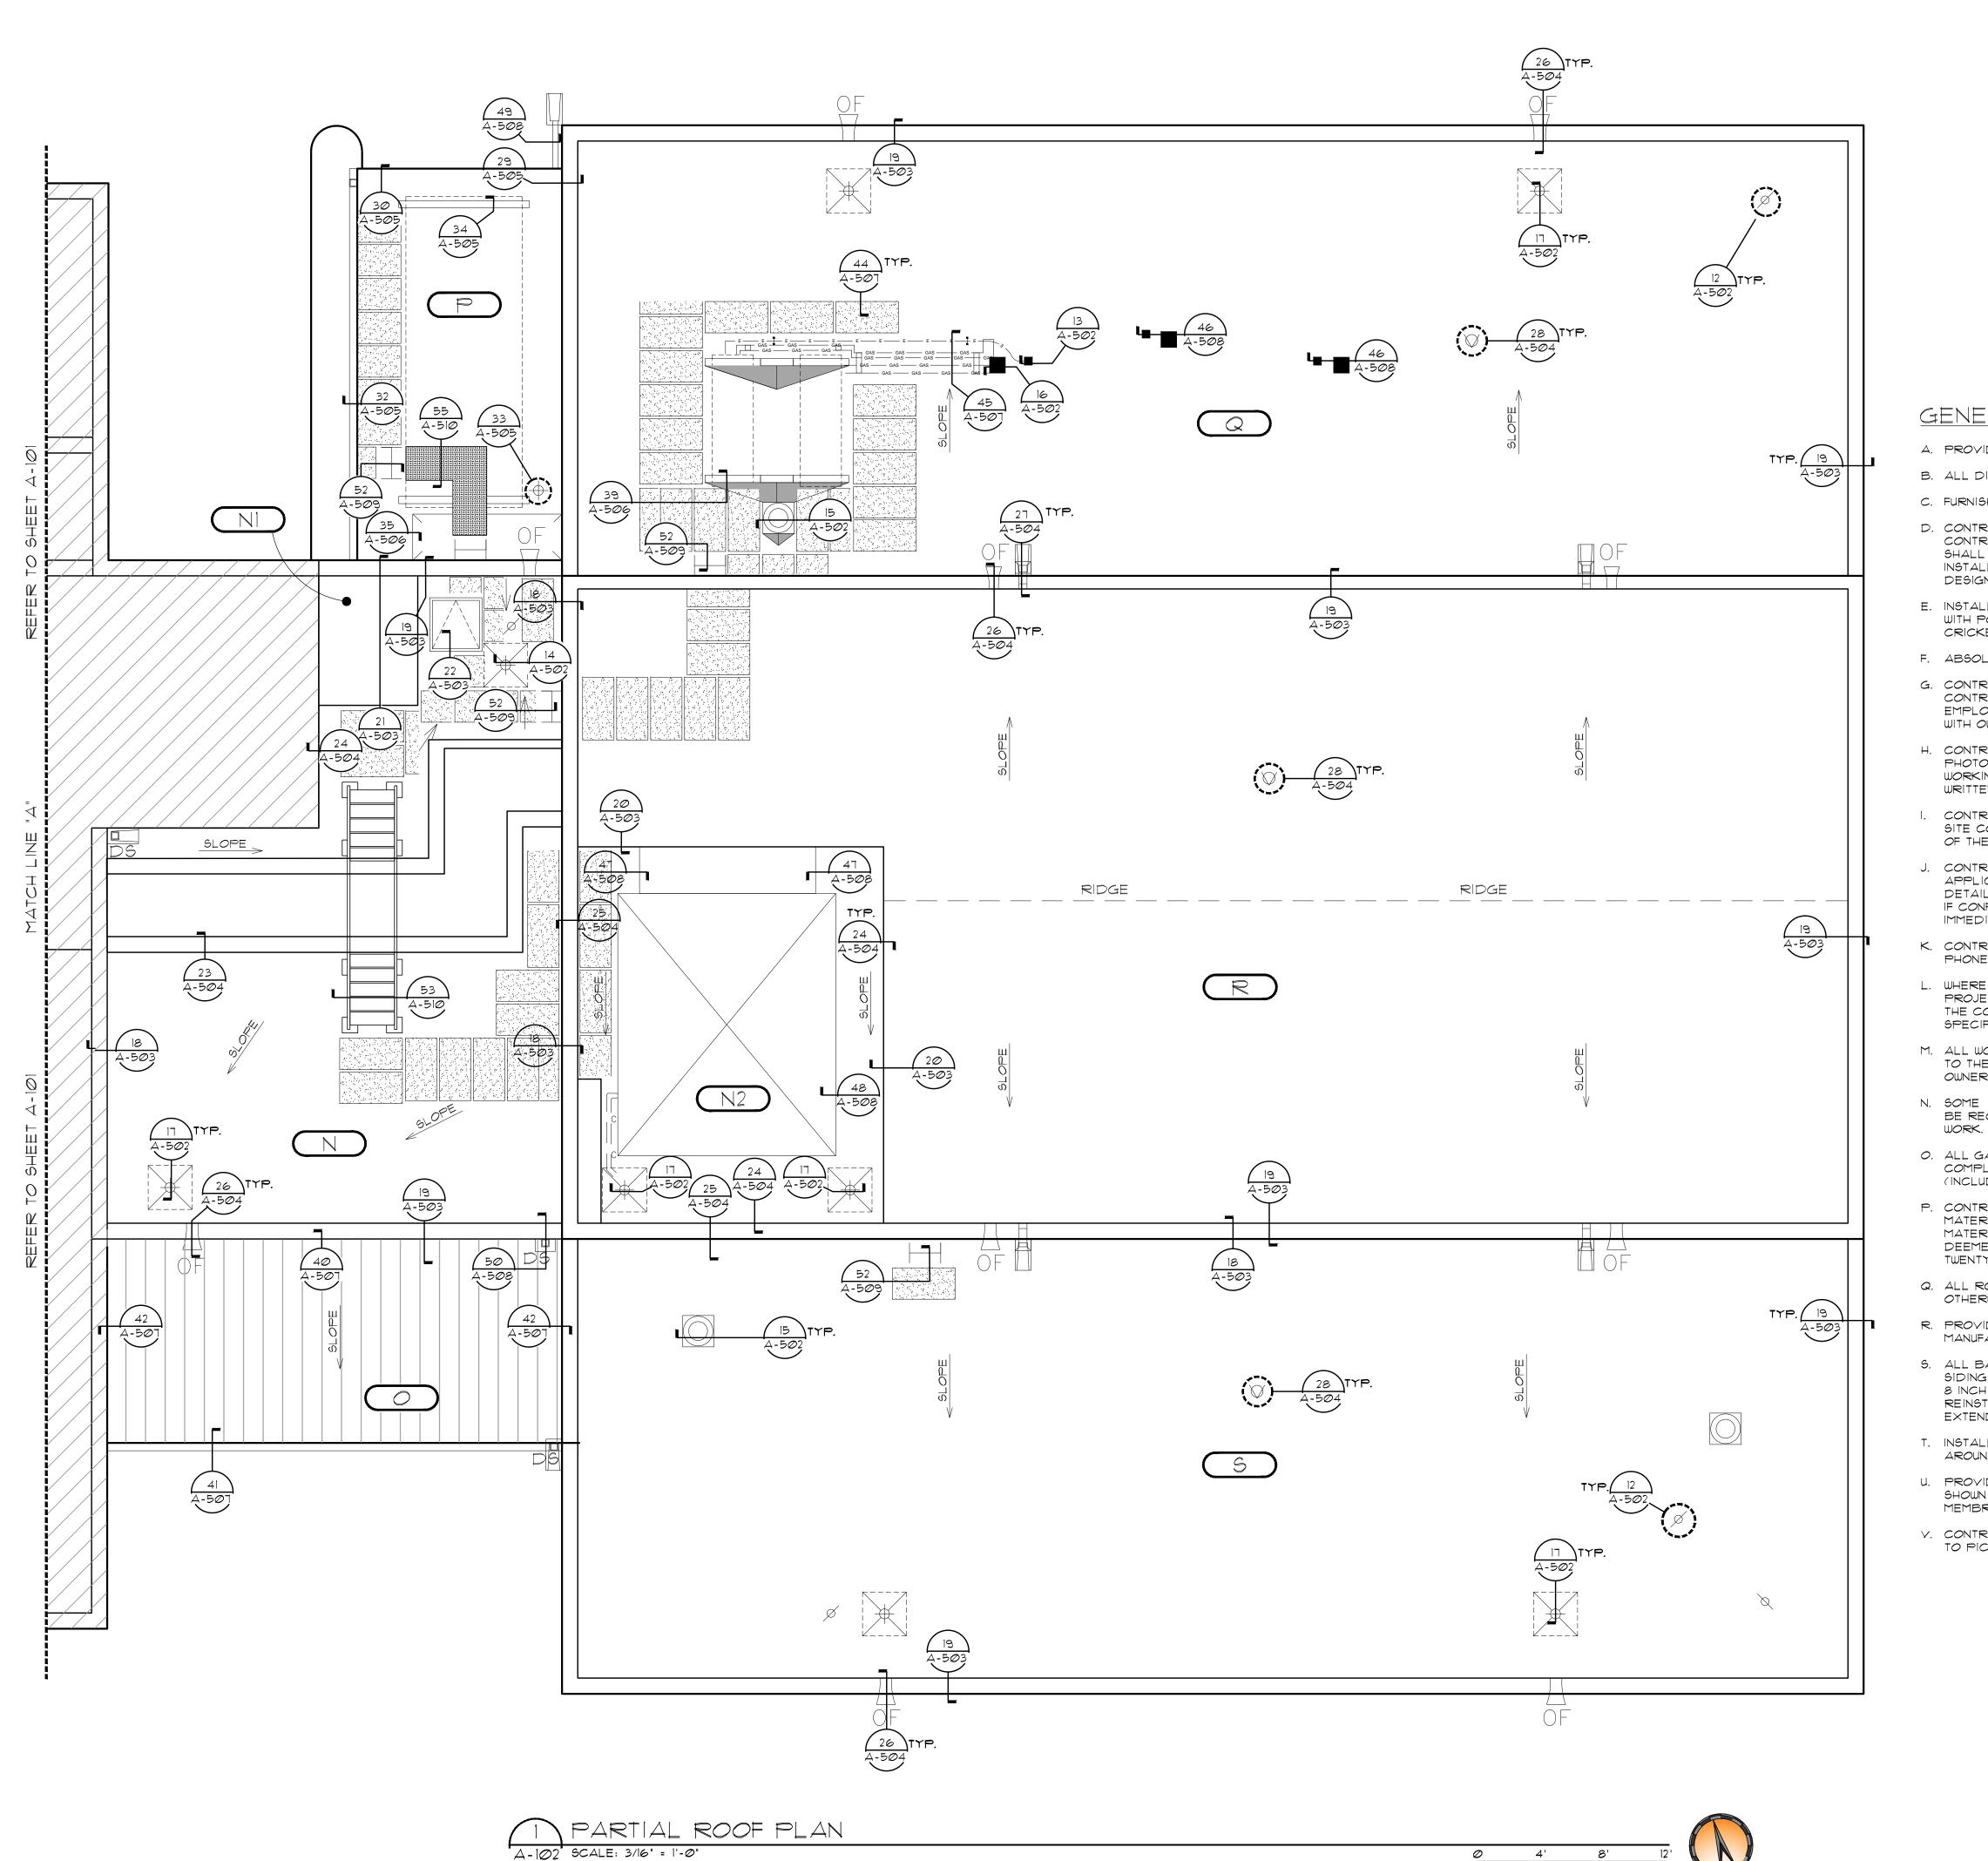

<u>DETAIL TAG</u> DETAIL NUMBER

DETAIL SHEET #

GENERAL PROJECT NOTES:

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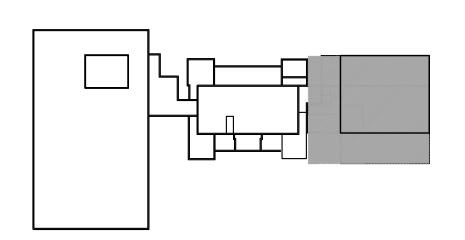
CRICKET

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0 01/27/2017 ISSUE FOR BID SET

PROJECT NO: 1-132-1

CAD DWG FILE: A-100 ROOF PLAN


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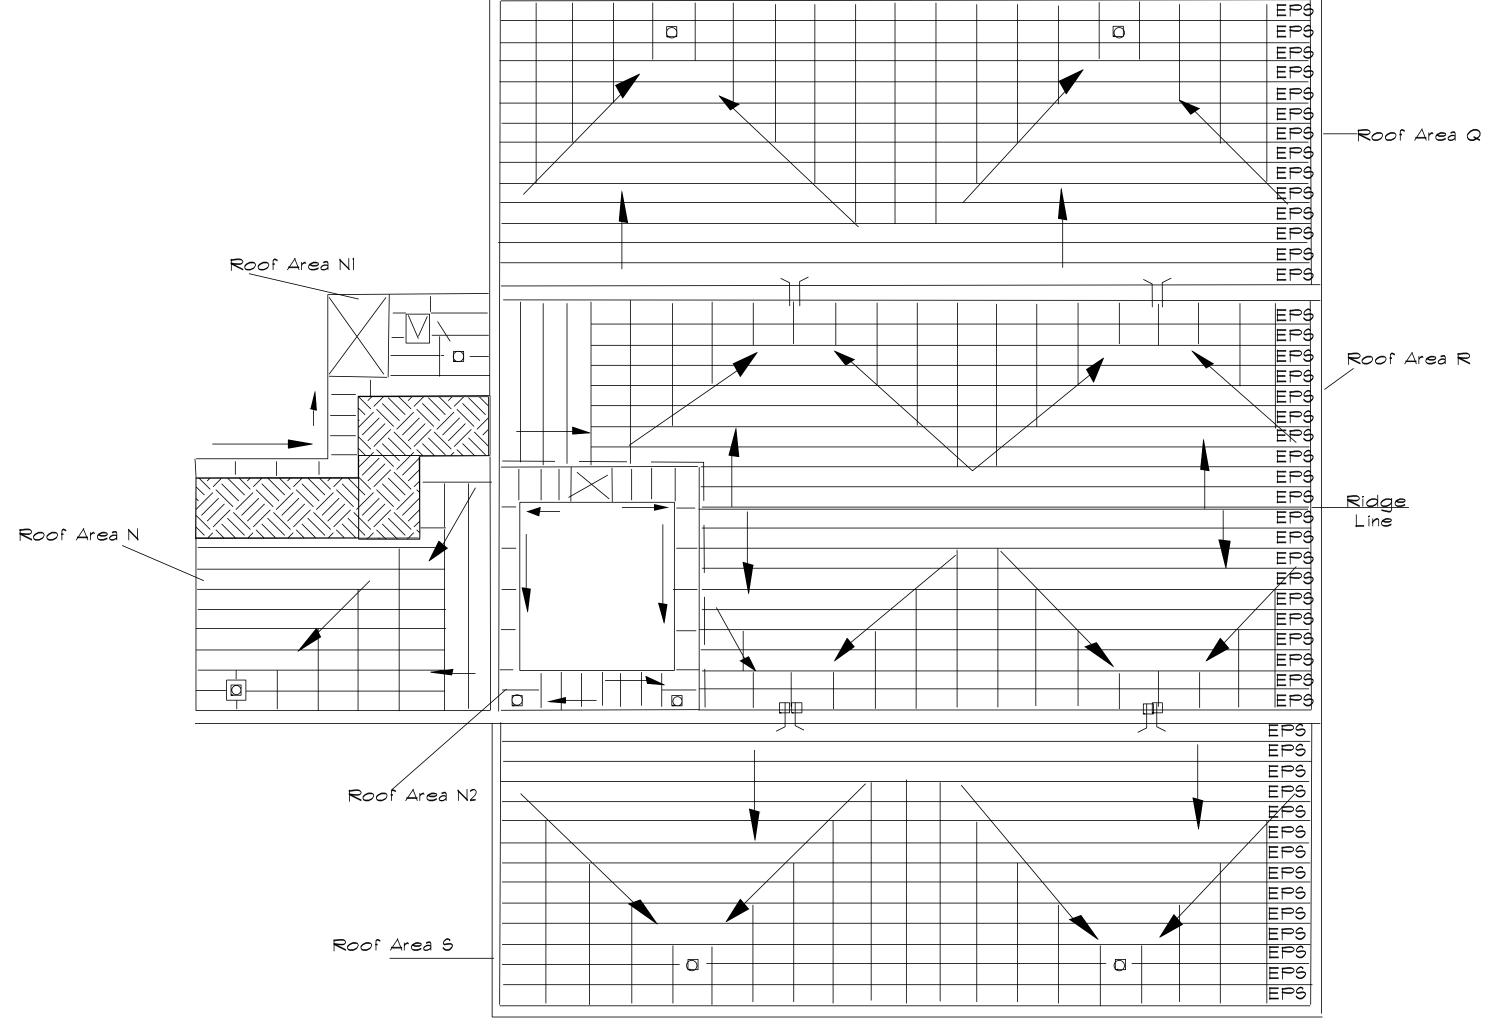
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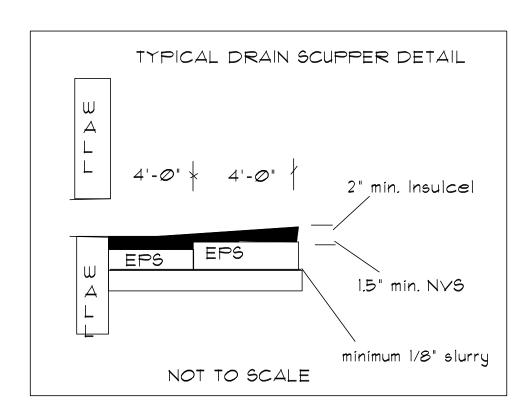
OCCUPANCY
GROUP: GROUP A


ROOF PLAN
AREAS: N,N1,N2,O,P,Q,R & S


SHEET NO. **Δ-10**





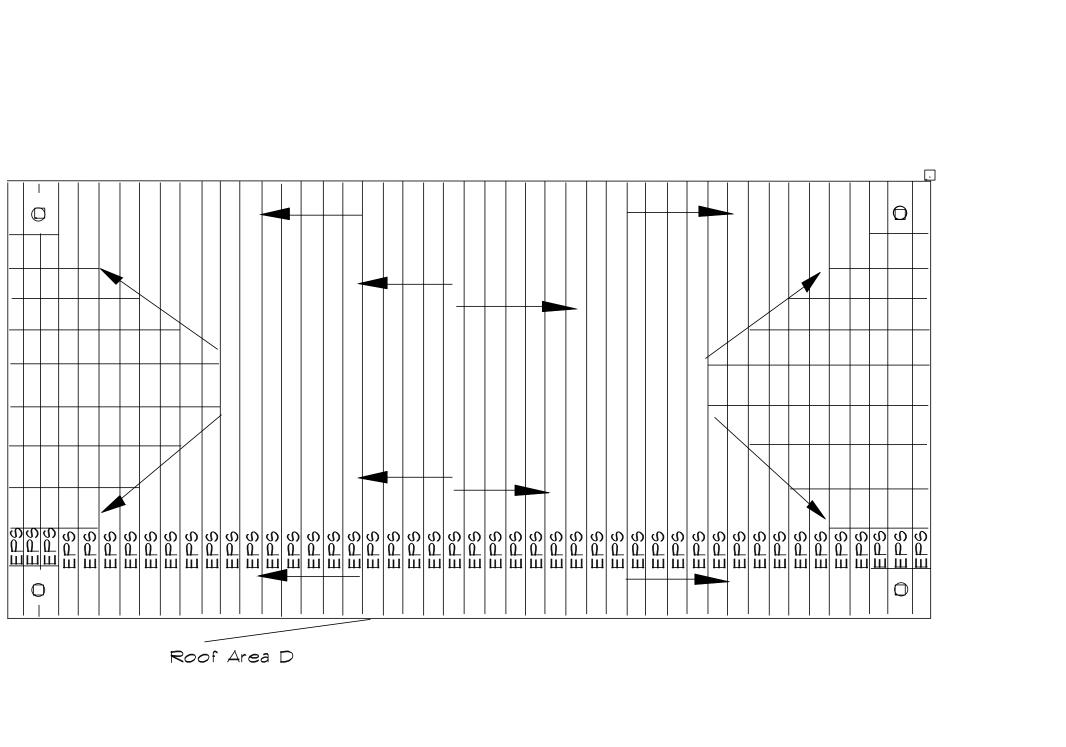

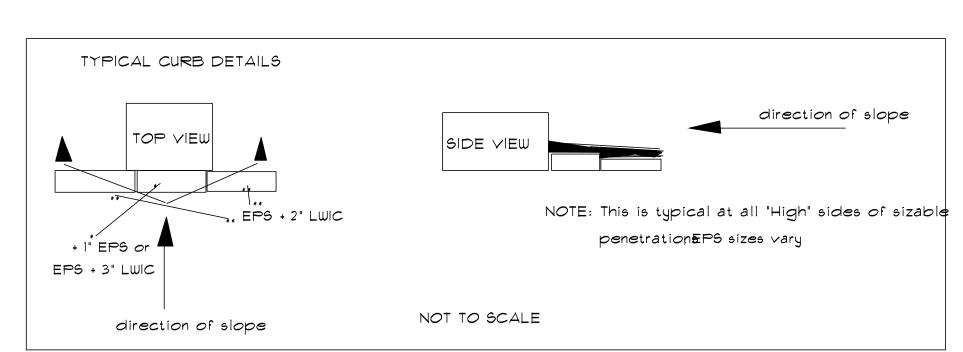

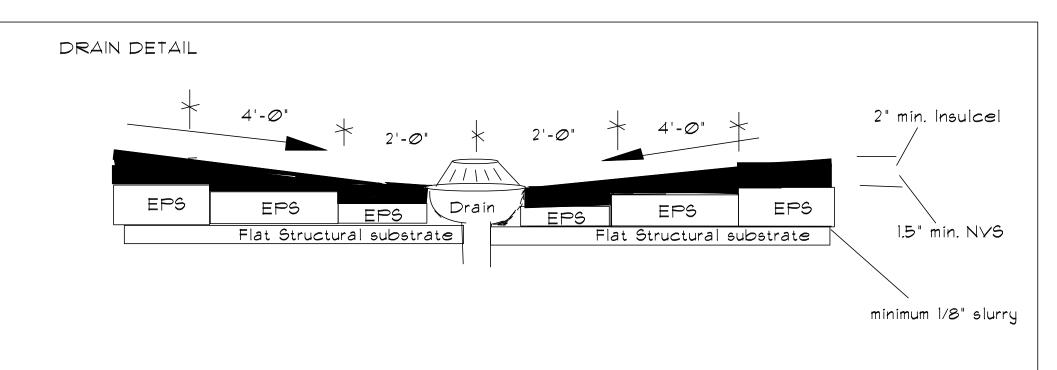

NOTE: THIS DRAINAGE PLAN IS BASED ON SIPLAST INSULCEL CELLULAR CONCRETE OR THEIR NYS AGGREGATE LIGHTWEIGHT INSULATING CONCRETE SYSTEMS.

BOTH SYSTEMS WILL USE SIPLAST INSULPERM EXPANDED POLYSTYRENE INSULATION BOARD FOR 1/8" SLOPE & MINMUM R-25. THE EPS INSULATION THICKNESS WILL REMAIN THE SAME, BUT THE TOPPING THICKNESS WILL BE A 2" MINIMUM THICKNESS FOR THE INSULCEL CELLULAR AND 1.5" MINIMUM FOR THE MINIMUM THICKNESS FOR THE NVS AGGREGATE SYSTEM.

GENERAL NOTES: NUMBERS IN BOX-LIKE OBJECTS INDICATE THE THICKNESS OF THE INSULPERM EPS INSULATION ONLY NOT THE TOPPING. TOPPING THICKNESS WILL BE DETERMINED BY WHICH SIPLAST LWIC SYSTEM USED. EPS INSULATION BOARDS ARE 2' X 4' WITH THICKNESSES SHOWN ON DRAWING.

DRAINS ARE SHOWN AS: 0 DRAIN SCUPPERS ARE SHOWN AS: ††

SLOPE DIRECTION IS SHOWN AS: ---

NOT ALL ROOF PENETRATIONS ARE SHOWN. THOSE NOT SHOWN WILL HAVE A CRICKET/WATER DIVERSION PLACED ON THE HIGH-SIDE OF THE DOWNWARD SLOPE USING ADDED THICKNESS OF LWIC OR EPS INSULATION.

FIELD ADJUSTMENTS MAY BE REQUIRED TO COMPENSATE FOR DIMENSIONAL CHANGES, FLASHING HEIGHTS, ...ETC.

INSTALLATION INSTRUCTIONS: PLACE FROM 1/8" TO 1/4" OF LWIC SLURRY PRIOR TO PLACING/EMBEDDING INSULPERM EPS INSULATION. PLACE EPS INSULATION USING THICKNESSES & IN ORDER SHOWN ON DRAWINGS.

ALLOW A BOND TO OCCUR BETWEEN THE EPS & THE ROOF DECK SUBSTRATE PRIOR TO PLACING THE LWIC TOPPING. THIS WILL PREVENT THE EPS INSULATION FROM "FLOATING". THE NVS SYTEM REQUIRES TOPPING WITHIN 4 HOURS. THE INSULCEL CELLULAR VARIES, DEPENDENT UPON THE WEATHER, 4 HOURS TO OVERNITE (OVERNITE IS BEST).
PLACE A MINIMUM THICKNESS OF (1.5" NVS & 2" INSULCEL CELLULAR) OVER THE TOP OF THE EMBEDDED EPS INSULATION. FINISH USING A STRAIGHTEDGE AND/OR FLOAT TO PROVIDE MINIMUM THICKNESS AND A

SMOOTH SURFACE ACCEPTABLE FOR THE ROOFING SYSTEM.
KEEP ALL NON-ESSENTIAL FOOT TRAFFIC OFF THE POURED TOPPING UNTIL IT CAN SUPPORT FOOT TRAFFIC WITHOUT INDENTATION. SCRAPE ANY SURFACE IRREGULARITIES AND REMOVE DEBRIS. IF NEEDED, ANY REPAIRE PERFORMED USING MANUFACTURER'S RECOMMMENDED MATERIALS & PROCEDURES.

LUC POUR LAYOUT PLAN SP-100 SCALE: N.T.S.





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THOUSE - ROOFING PROJECT

BID#2017-703
A ROOF REPLACEMENT AT
GREGG COUNTY COURTH(

REV. DATE: DESCRIPTION:

0 01/27/2017 ISSUE FOR BID SET

PROJECT NO: 1-132-1

CAD DWG FILE: SP-100 LWC POUR PLAN


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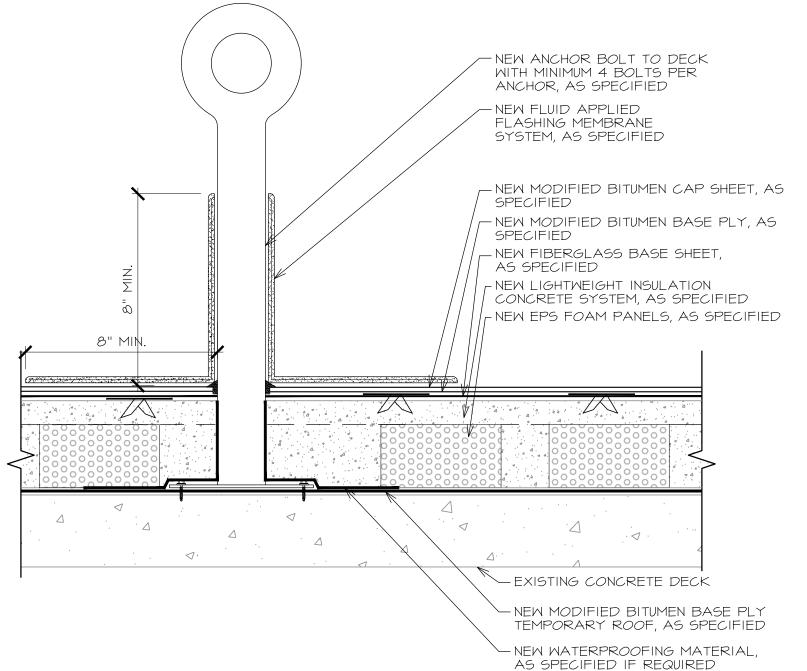
CHECKED BY: VC


OCCUPANCY
GROUP: GROUP A


SHEET TITLE:
LWC POUR LAYOUT PLAN

[№]SP-100



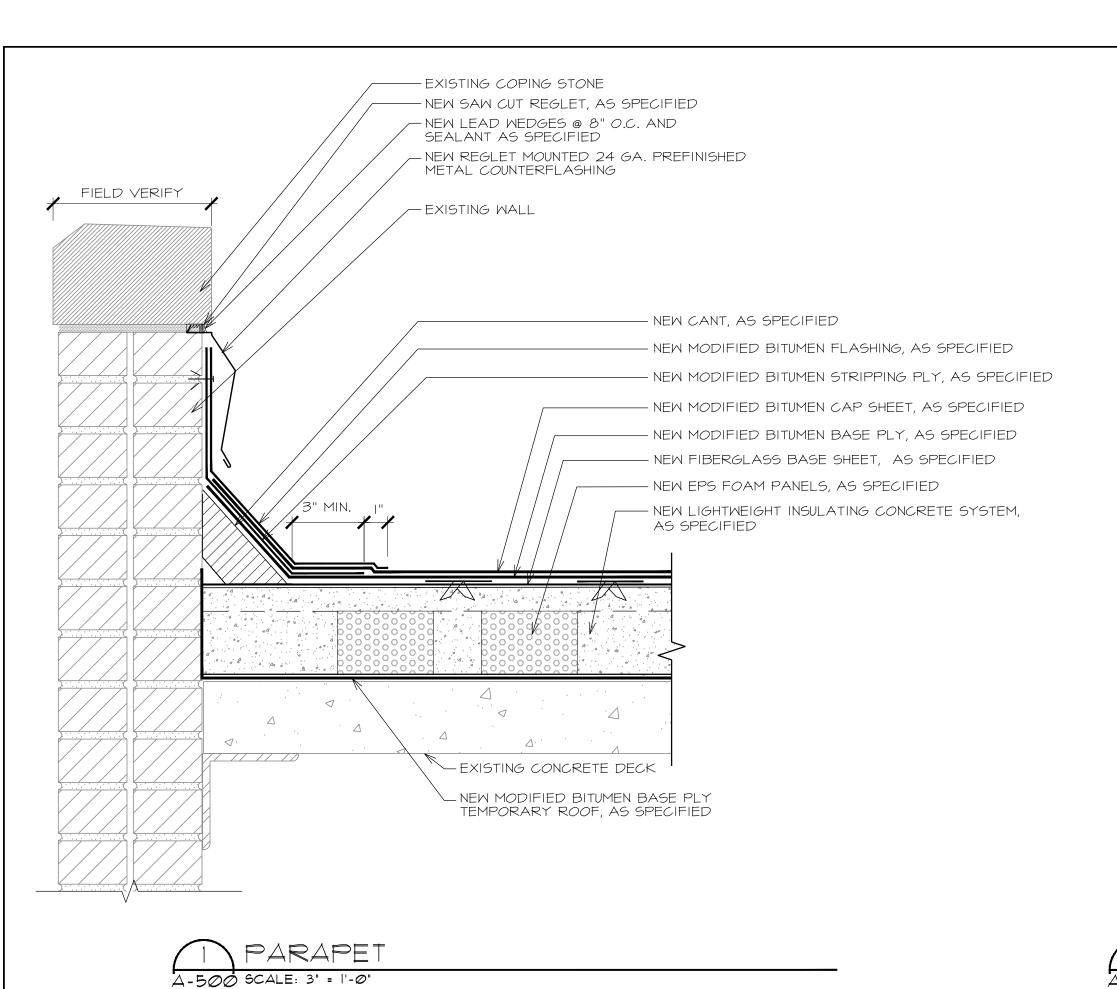

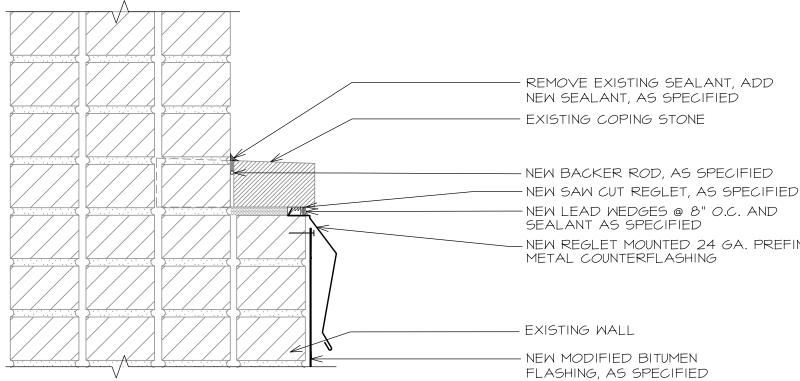

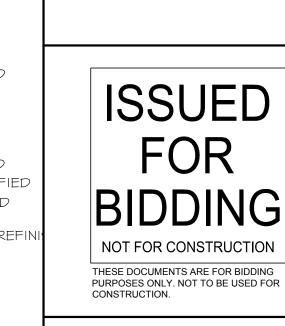

PROJE

Consulting Group, LLC

DFW OFFICE

616 SOUTH COPPELL RD

COPPELL, TX 75019

PHONE:214.758.0785

AMARILLO OFFICE


7120 I-40 WEST, SUITE 210 AMARILLO, TX 79106

PHONE: 806.356.6059


roof consulting & design

2 GUY WIRE ANCHOR DETAIL A-500 SCALE: 3" = 1'-0"


MPED ROOF DRAIN

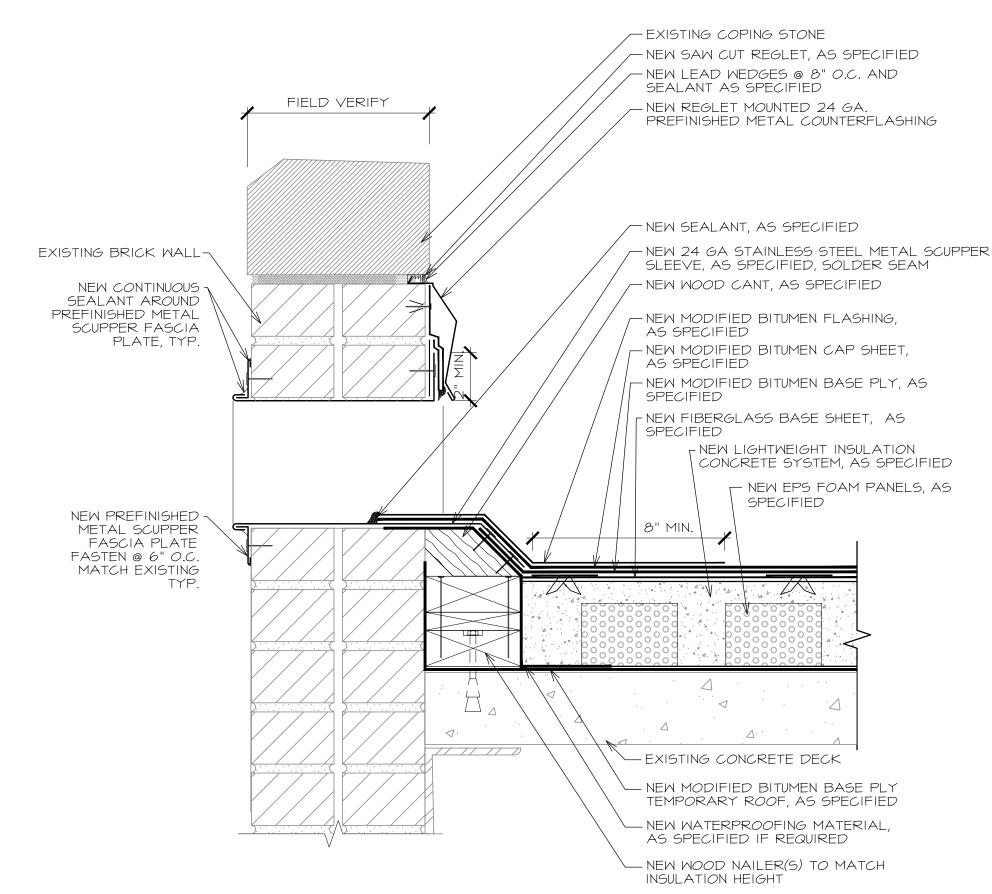

6 THRU-WALL OVERFLOW SCUPPER (NEW) A-500 SCALE: 3" = 1'-0"

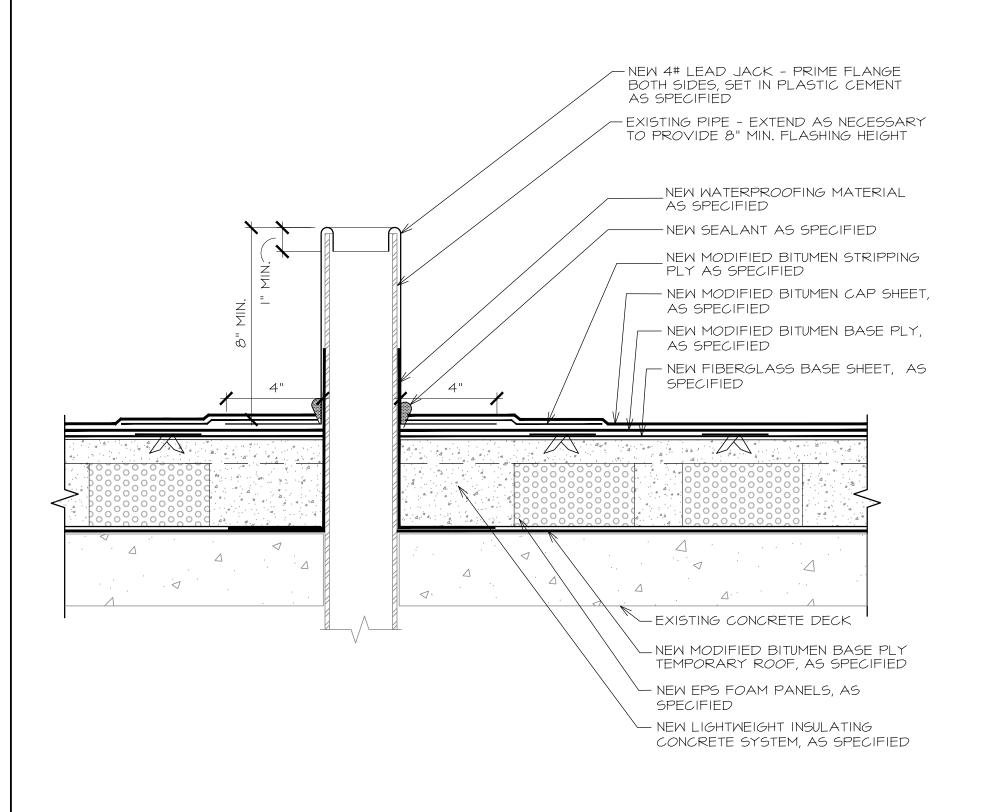



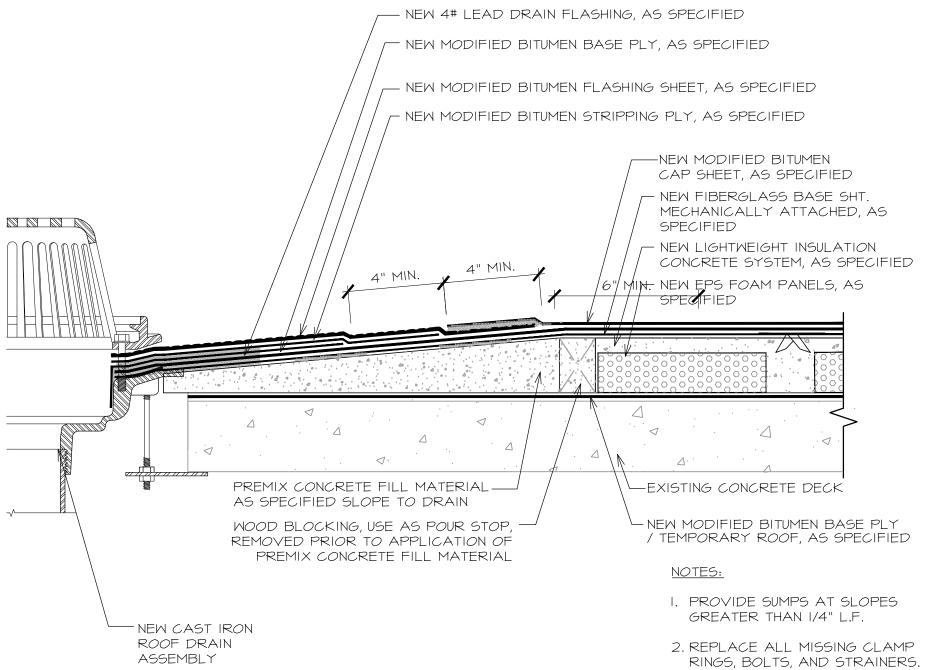

4. REMOVE CONCRETE STOP
BLOCKING PRIOR TO FINAL
LIGHTWEIGHT CONCRETE POUR

6 THRU-WALL OVER

3. PAINT ALL DRAIN STRAINERS

PROJECT NO: 1-132-1
CAD DWG FILE: A-500 DETAILS
DRAWN BY: AA
CHECKED BY: VC
OCCUPANCY
GROUP: GROUP A
SHEET TITLE:


0 01/27/2017 ISSUE FOR BID SET

IDESCRIPTION:

COURTHOU

DETAILS

SHEET NO. Λ

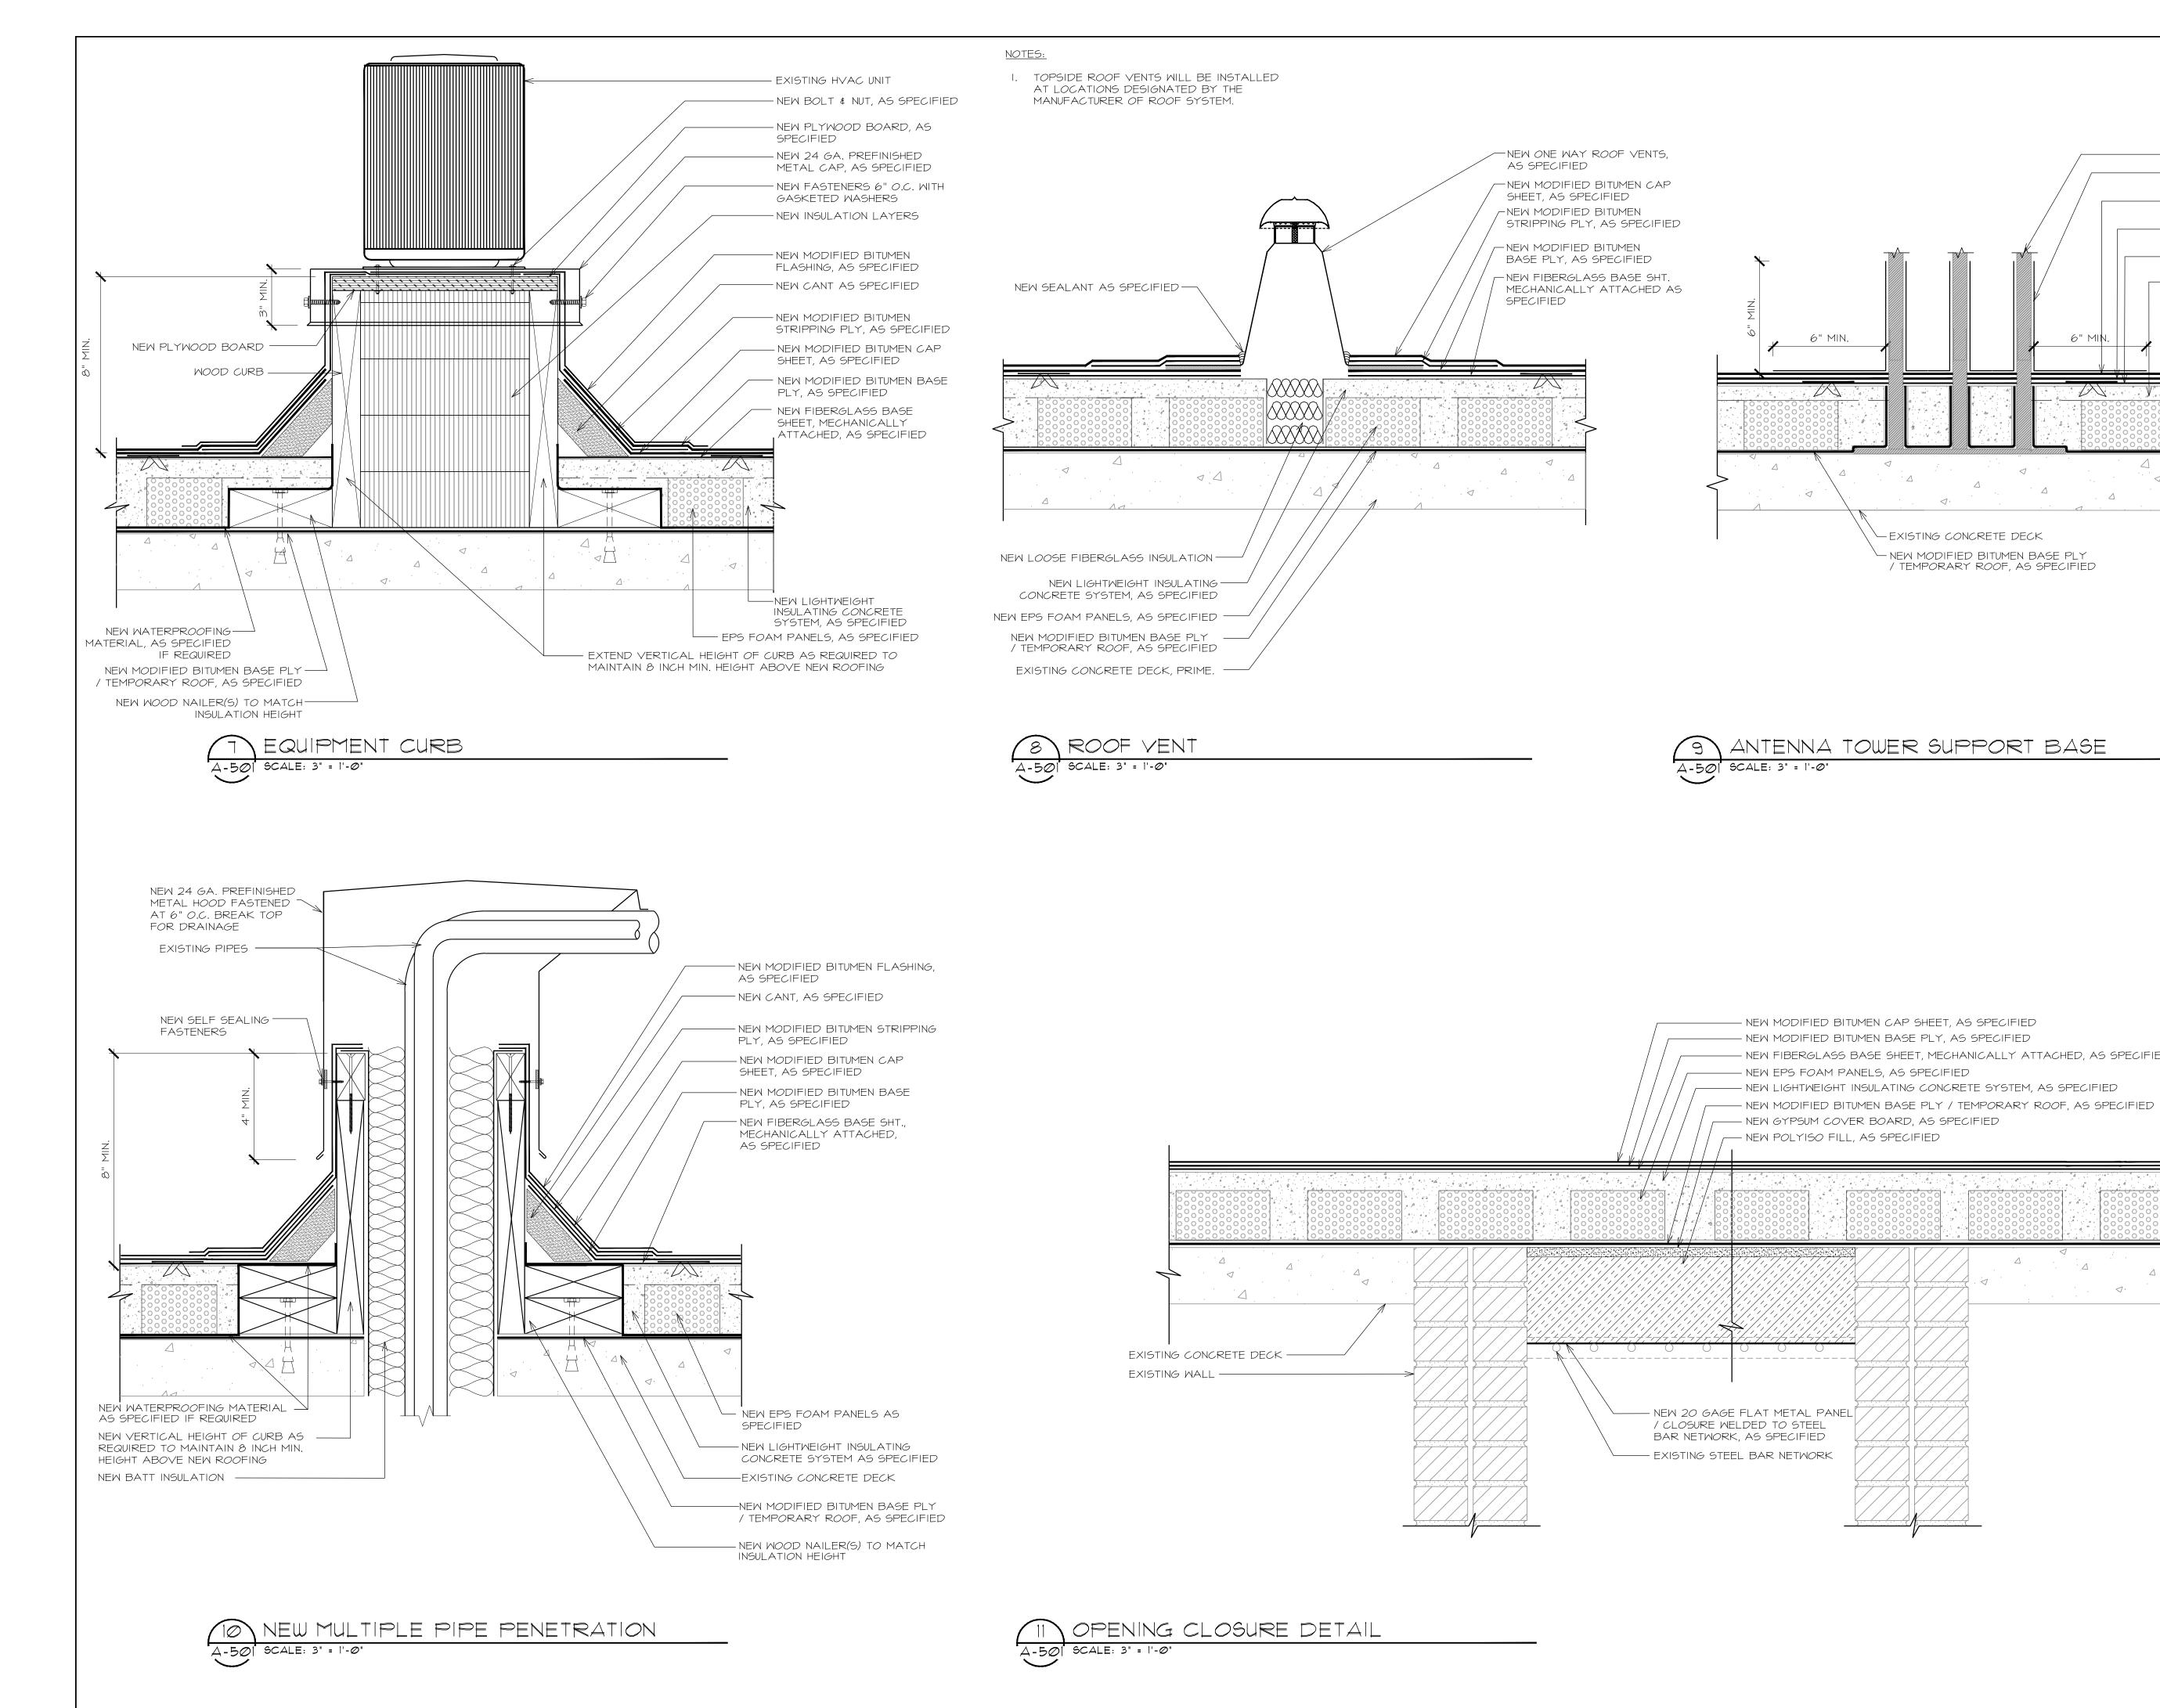



-EXISTING ANTENNA TOWER

— NEW LIGHTWEIGHT INSULATING

- NEW EPS FOAM PANELS, AS

SPECIFIED

SPECIFIED

SPECIFIED

SPECIFIED

6" MIN.

- EXISTING CONCRETE DECK

- NEW MODIFIED BITUMEN CAP SHEET, AS SPECIFIED

- NEW MODIFIED BITUMEN BASE PLY, AS SPECIFIED

- NEW FIBERGLASS BASE SHEET, MECHANICALLY ATTACHED, AS SPECIFIED

NEW MODIFIED BITUMEN BASE PLY / TEMPORARY ROOF, AS SPECIFIED

6" MIN.

AS SPECIFIED

- NEW FLUID-APPLIED FLASHING, AS

- NEW MODIFIED BITUMEN CAP SHEET,

- NEW MODIFIED BITUMEN BASE PLY, AS

- NEW FIBERGLASS BASE SHEET, AS

CONCRETE SYSTEM, AS SPECIFIED

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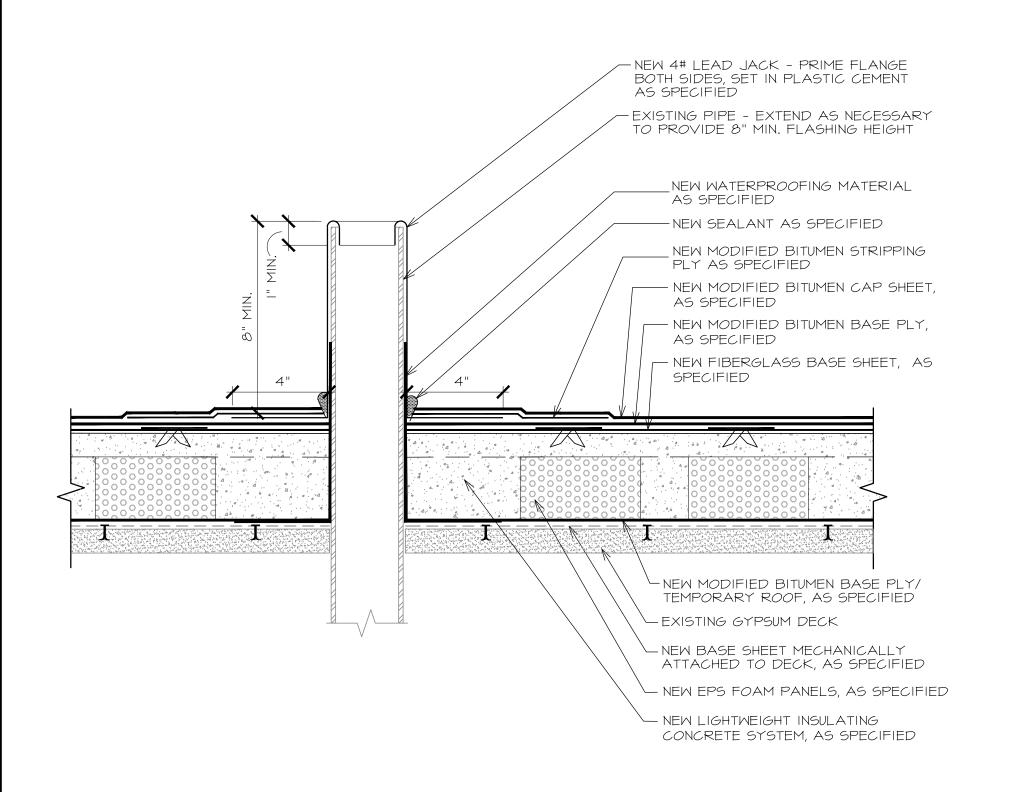
PURPOSES ONLY. NOT TO BE USED FOR


PROJE


CONSTRUCTION.

DESCRIPTION: 0 01/27/2017 ISSUE FOR BID SET PROJECT NO: 1-132-1 CAD DWG FILE: A-500 DETAILS DRAWN BY: CHECKED BY: OCCUPANCY GROUP: SHEET TITLE:

DETAILS



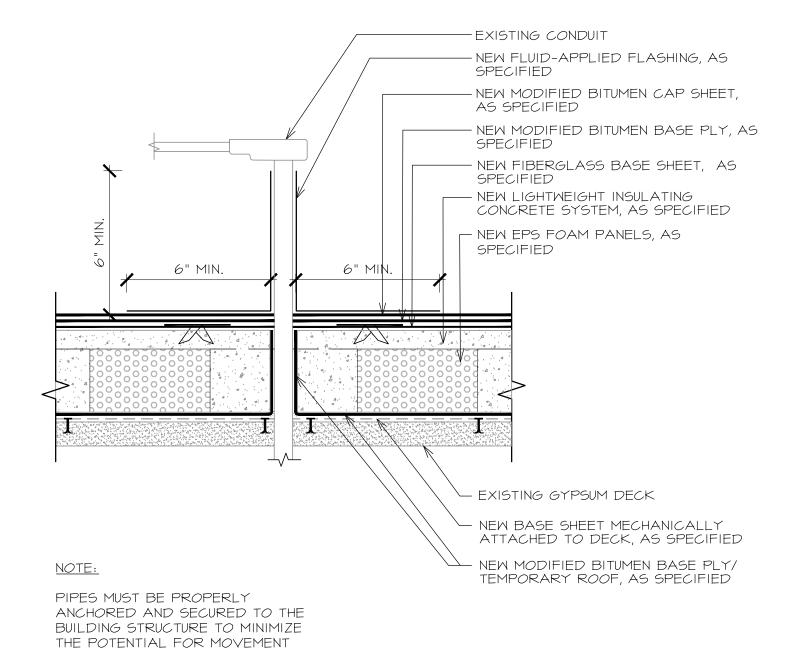

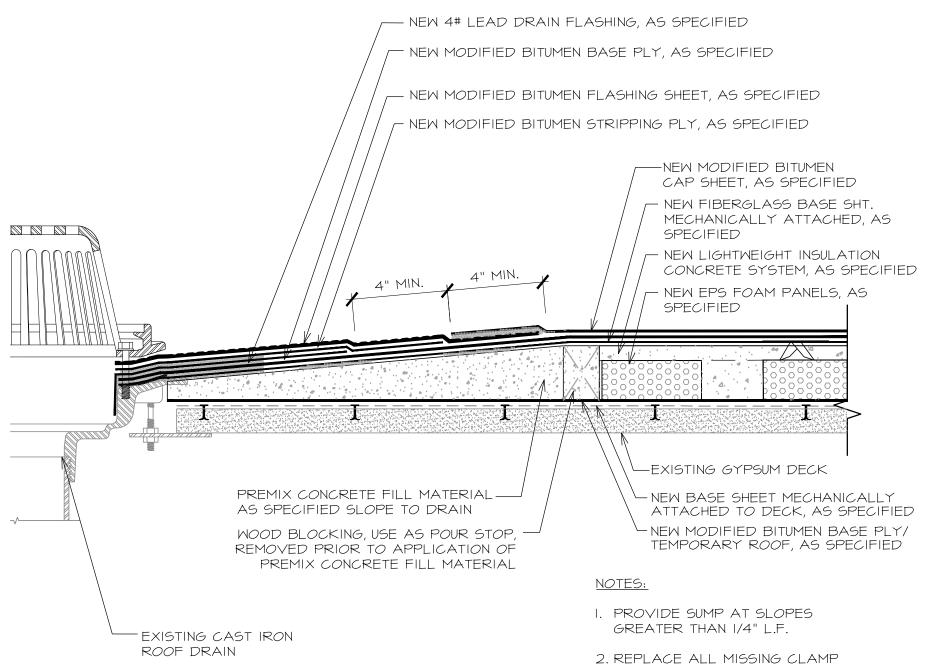

RINGS, BOLTS, AND STRAINERS. 3. PAINT ALL DRAIN STRAINERS


4. REMOVE CONCRETE STOP BLOCKING PRIOR TO FINAL LIGHT CONCRETE POUR

WASTE STACK $\triangle - 5002$ SCALE: 3" = 1'-0''

CONDUIT FLASHING PENETRATION A-502 SCALE: 3" = 1'-0"

<u>NOTE:</u>


CONDUIT MUST BE PROPERLY ANCHORED AND SECURED TO THE BUILDING STRUCTURE TO MINIMIZE THE POTENTIAL FOR MOVEMENT

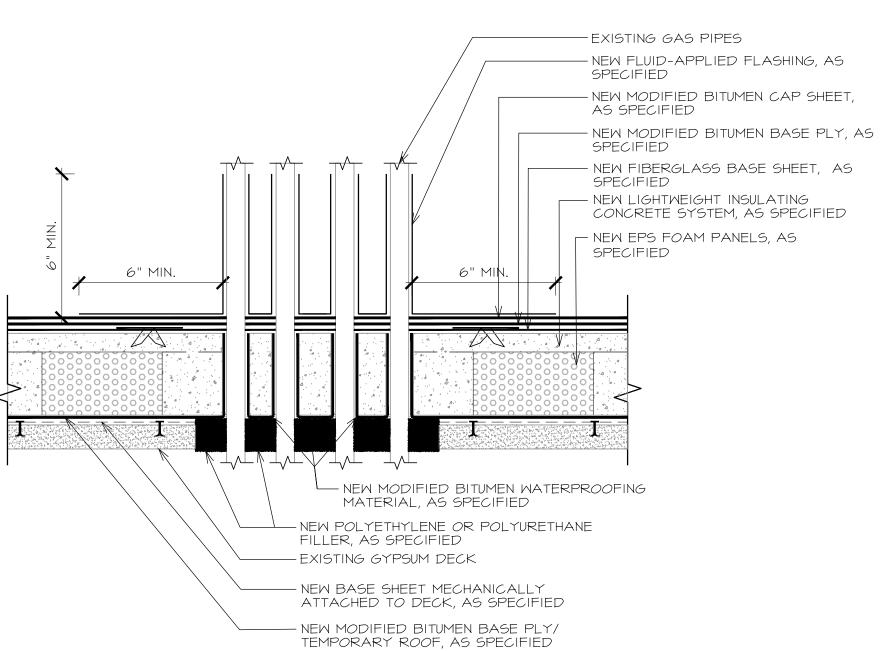





SUMPED ROOF DRAIN

NOTE:

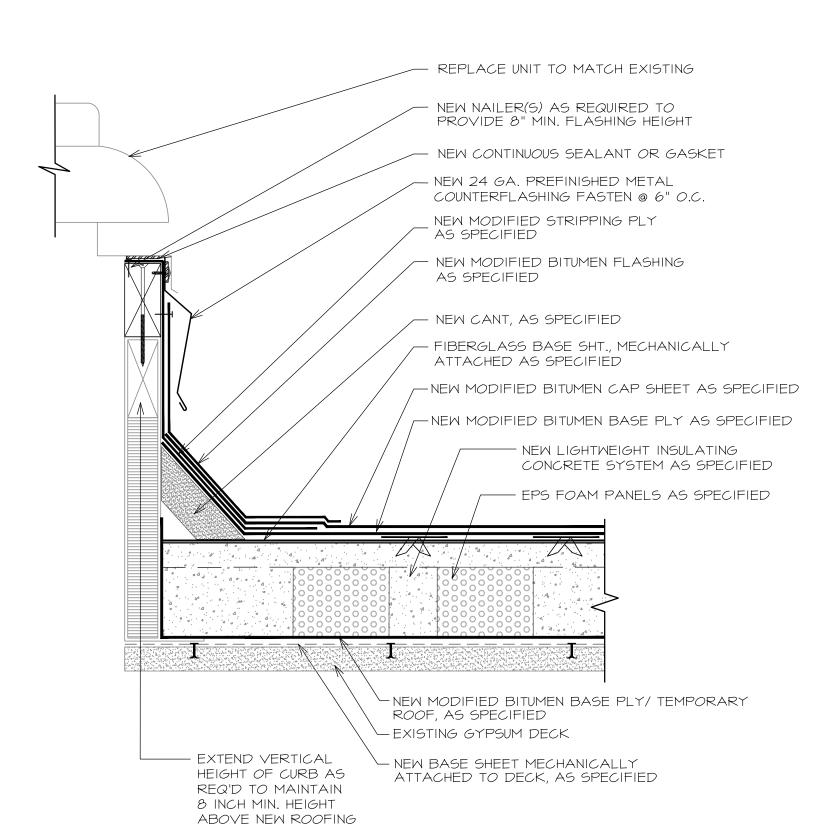

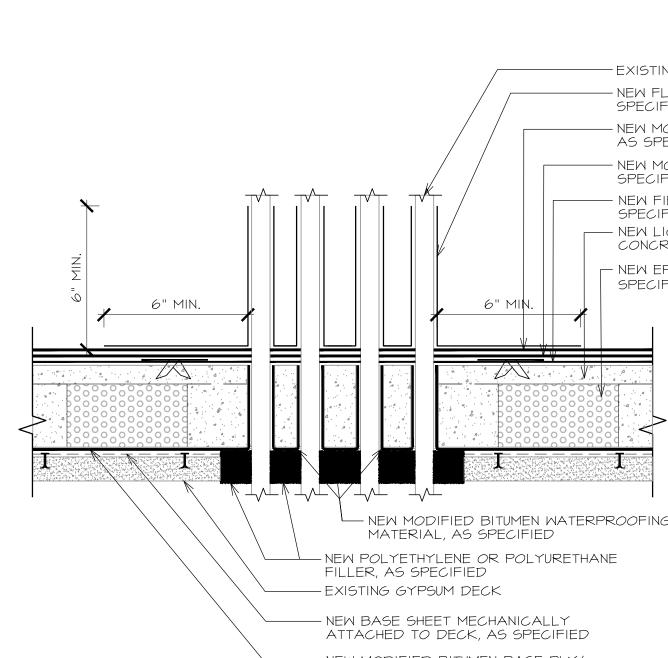



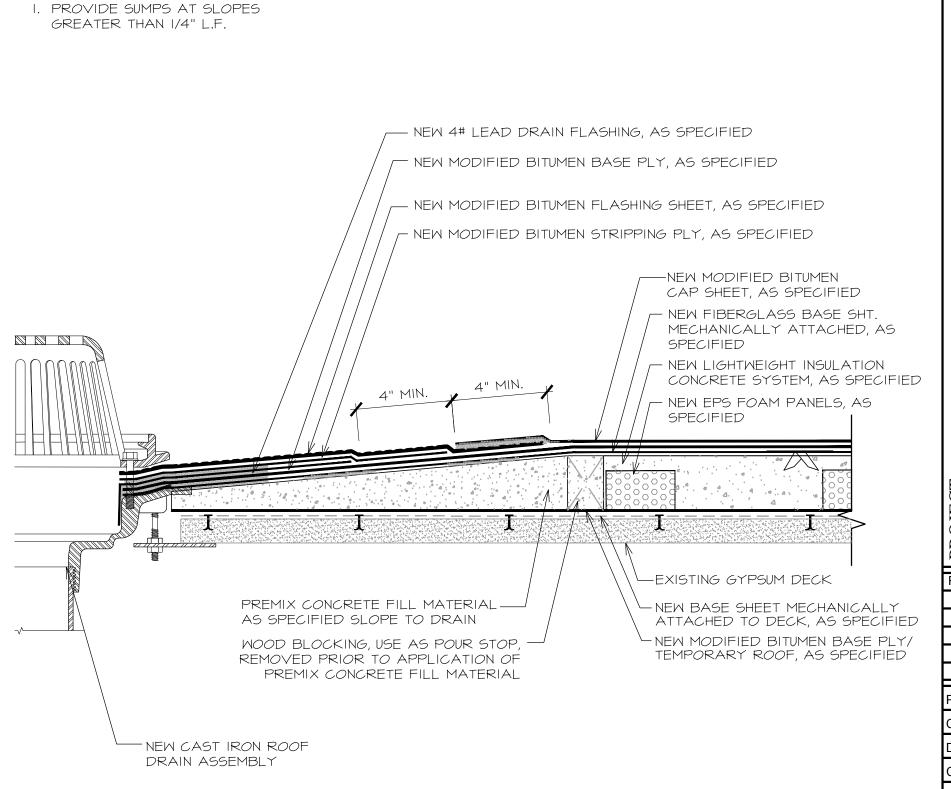

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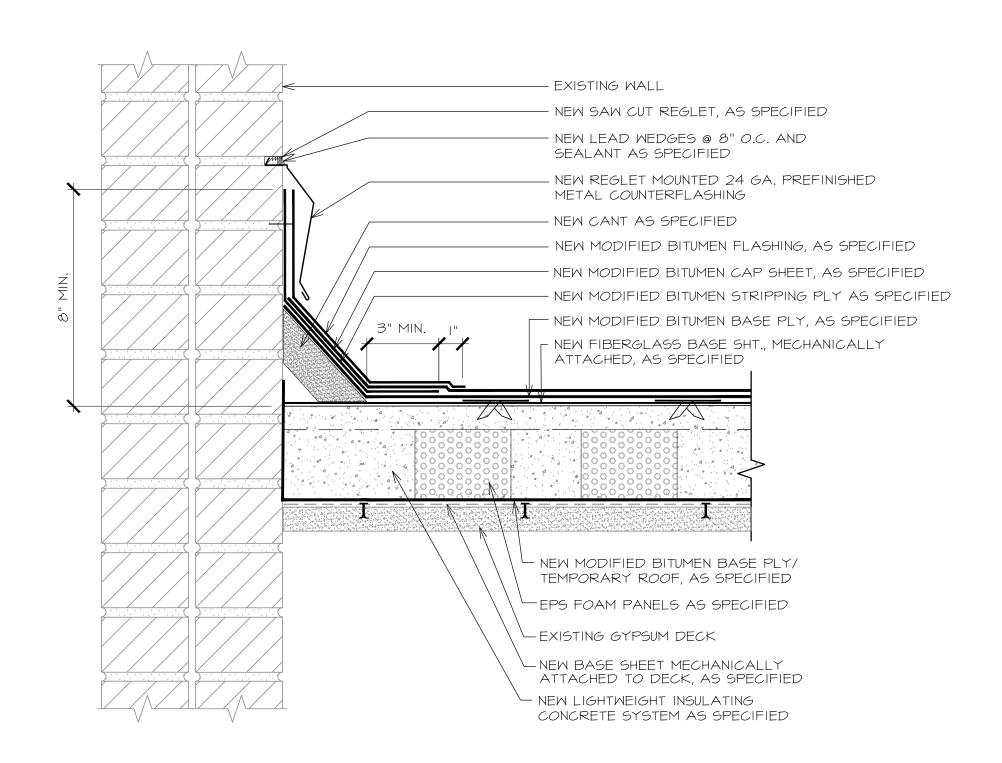
COURTHOU

DESCRIPTION: 0 01/27/2017 ISSUE FOR BID SET PROJECT NO: 1-132-1 CAD DWG FILE: A-500 DETAILS DRAWN BY: CHECKED BY: OCCUPANCY


DETAILS

GROUP:

POWER VENT



SCALE: 3" = 1'-0"

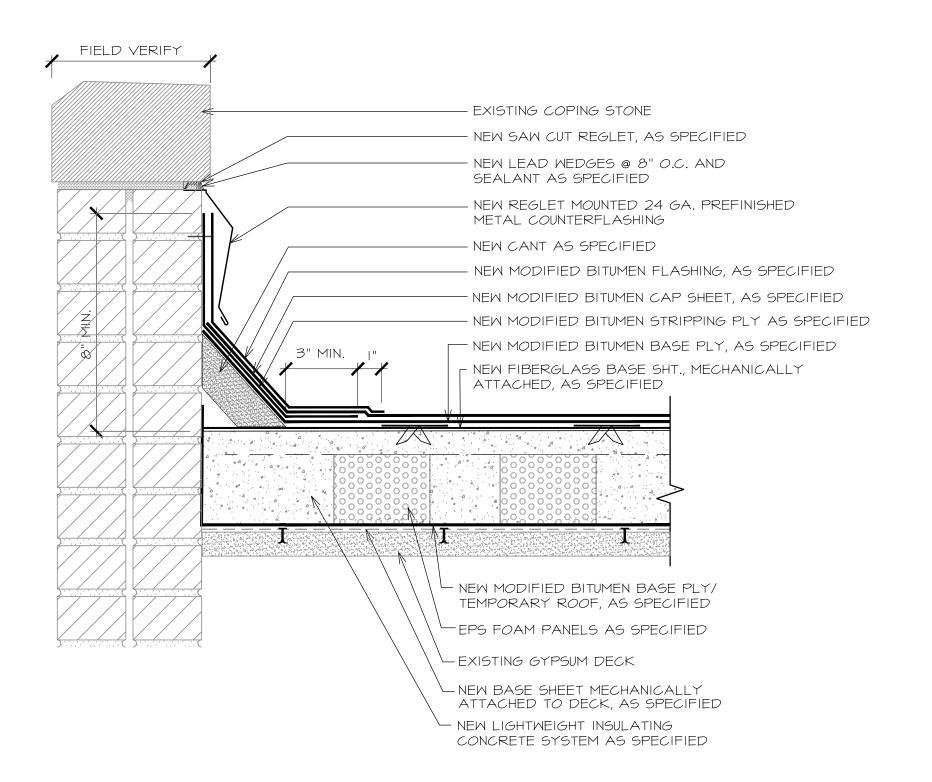




-NEW BASE SHEET MECHANICALLY igspace NEW MODIFIED BITUMEN BASE PLY/ ATTACHED TO DECK, AS SPECIFIED TEMPORARY ROOF, AS SPECIFIED


- EXISTING COPING STONE - NEW SAW CUT REGLET, AS SPECIFIED -NEW LEAD WEDGES @ 8" O.C. AND FIELD VERIFY SEALANT AS SPECIFIED NEW REGLET MOUNTED 24 GA. PREFINISHED METAL COUNTERFLASHING -NEW MODIFIED BITUMEN STRIPPING PLY, AS SPECIFIED NEW CANT, AS SPECIFIED NEW MODIFIED BITUMEN FLASHING, AS SPECIFIED - NEW MODIFIED BITUMEN CAP SHEET, AS SPECIFIED - NEW MODIFIED BITUMEN BASE PLY, AS SPECIFIED - NEW FIBERGLASS BASE SHT., MECHANICALLY ATTACHED, AS SPECIFIED - NEW SEALANT, AS SPECIFIED - NEW 24 GA. PREFINISHED METAL EDGE FASTEN @ 6" O.C. — NEW 22 GA. CLEAT FASTEN 6" O.C. - NEW WOOD NAILERS TO MATCH INSULATION THICKNESS, AS SPECIFIED LNEW MODIFIED BITUMEN BASE PLY/ TEMPORARY ROOF, AS SPECIFIED L NEW EPS FOAM PANELS, AS SPECIFIED - NEW LIGHTWEIGHT INSULATING CONCRETE SYSTEM, AS SPECIFIED - EXISTING WALL -EXISTING GYPSUM DECK —

CURB / PARAPET DETAIL A-503 SCALE: 3" = 1'-0"

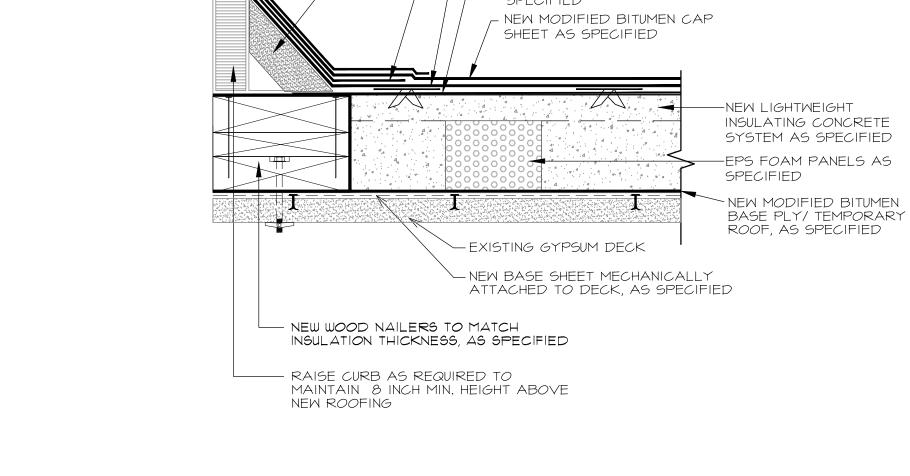

<u>NOTE:</u>

DETAIL BELOW SHOWS EQUAL LEVEL BETWEEN ROOF EDGE AND LIGHTWEIGHT INSULATION CONCRETE. LEVELS WILL VARY AT VARIOUS LOCATIONS ALONG BOTH LENGTHS OF THIS

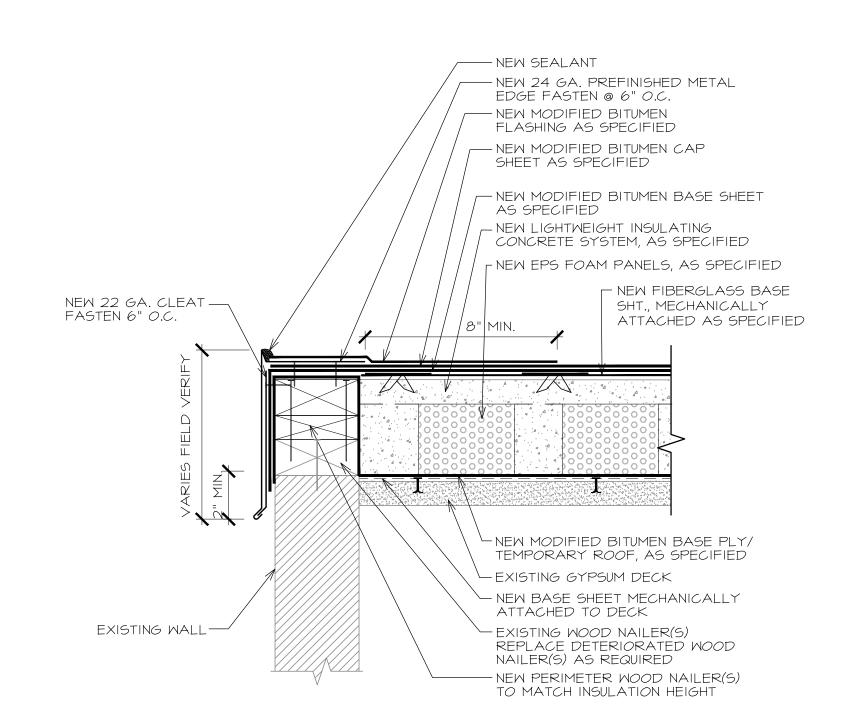



-EXISTING ROOF HATCH

- NEW CANT, AS SPECIFIED

---- NEW MODIFIED BITUMEN BASE

NEW FIBERGLASS BASE SHEET,

MECHANICALLY ATTACHED AS

AS SPECIFIED

PLY AS SPECIFIED

PLY AS SPECIFIED

- NEW 24 GA. PREFINISHED METAL COUNTERFLASHING FASTEN @ 6" O.C.

NEW MODIFIED BITUMEN FLASHING

- NEW MODIFIED BITUMEN STRIPPING



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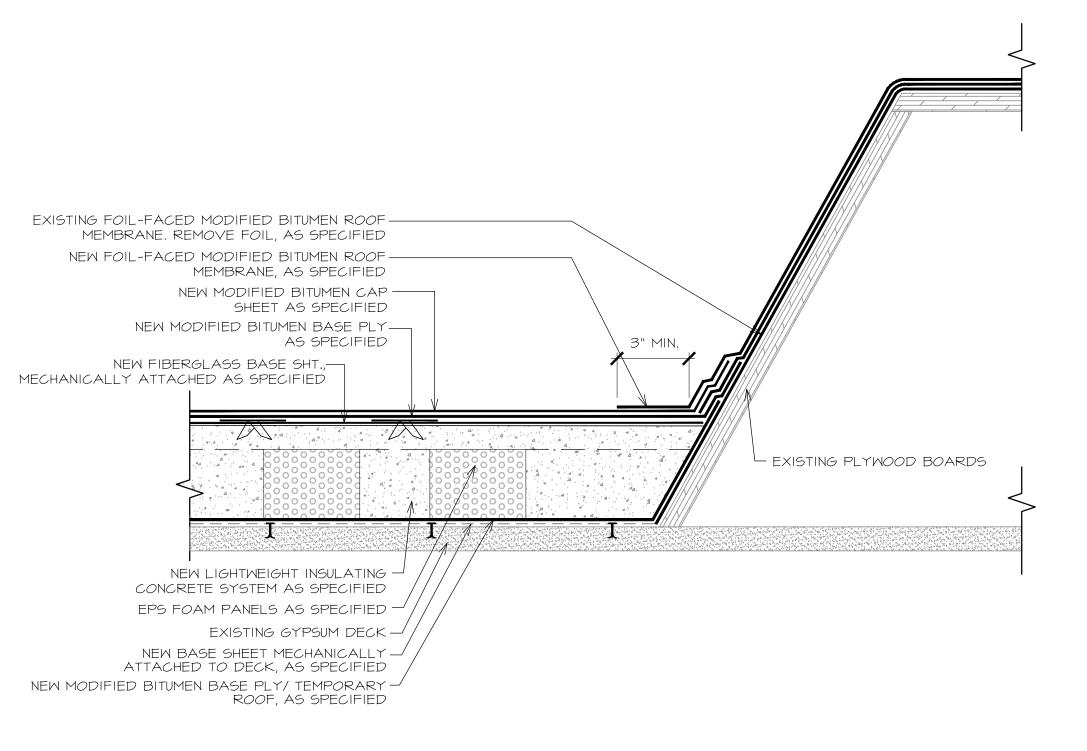
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-EXISTING COPING STONE

SEALANT AS SPECIFIED

- NEW SEALANT, AS SPECIFIED

SPECIFIED

AS SPECIFIED

ROOF, AS SPECIFIED - EXISTING GYPSUM DECK

INSULATION HEIGHT

SPECIFIED

- NEW SAW CUT REGLET, AS SPECIFIED

TUNNEL-WAY DETAIL

FIELD VERIFY

A-504 SCALE: 3" = 1'-0"

NEW CONTINUOUS

SEALANT AROUND

SCUPPER FASCIA

NEW PREFINISHED -


FASTEN @ 6" O.C MATCH EXISTING TYP.

METAL SCUPPER


FASCIA PLATE

PLATE, TYP.

PREFINISHED METAL

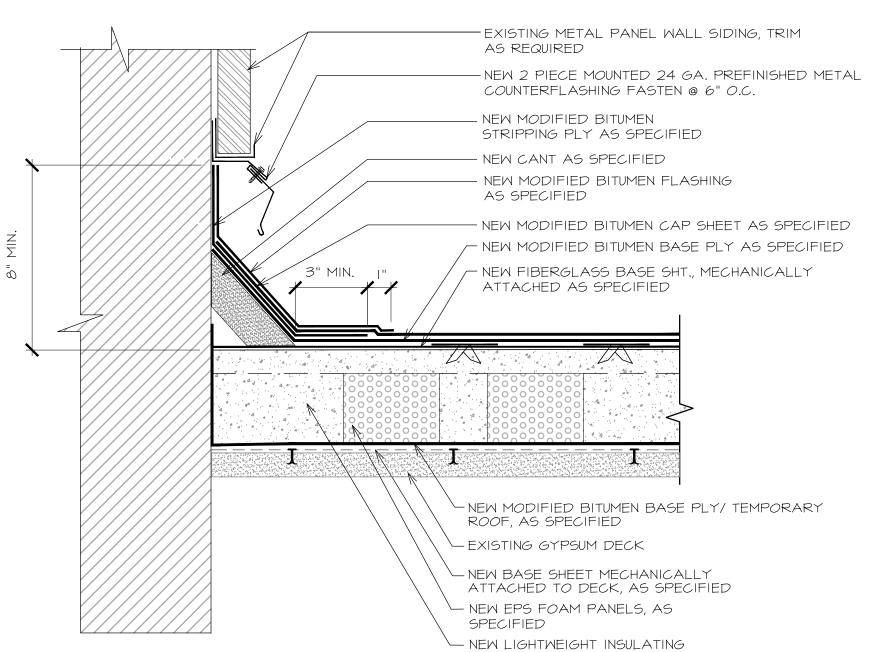

CONCRETE SYSTEM, AS SPECIFIED

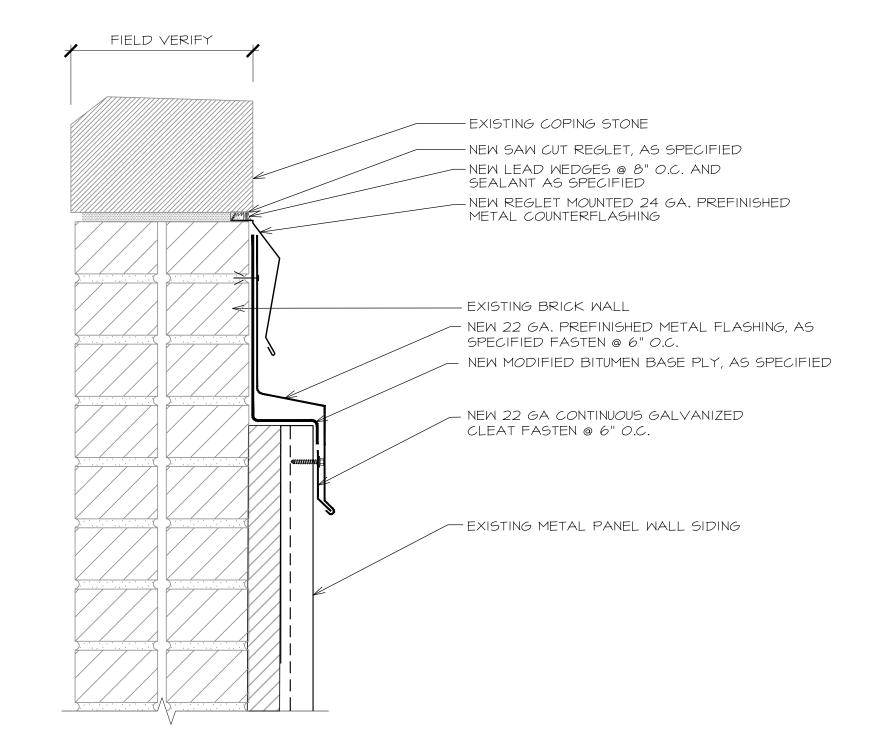





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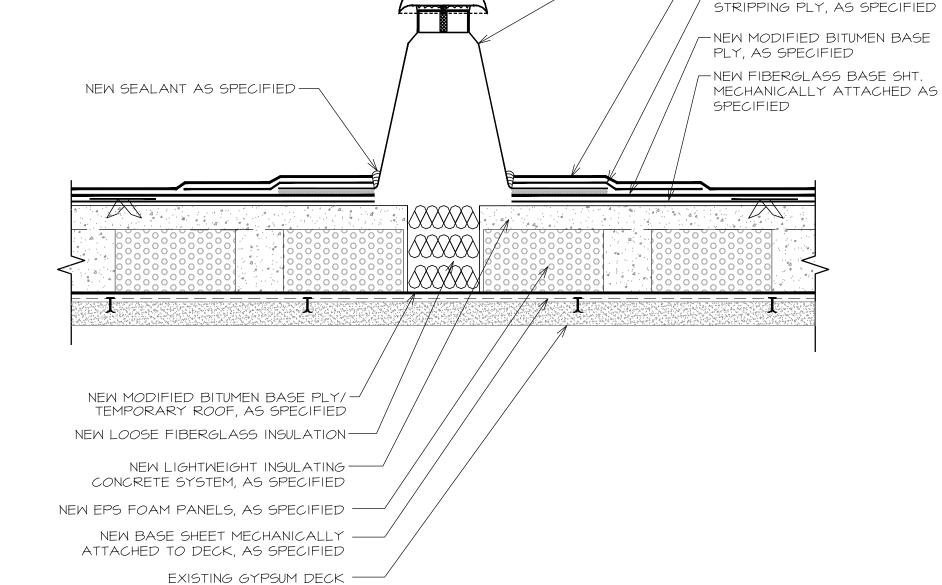
TOPSIDE ROOF VENTS WILL BE INSTALLED AT

LOCATIONS DESIGNATED BY THE MANUFACTURER OF ROOF SYSTEM.

4-504 SCALE: 3" = 1'-0"



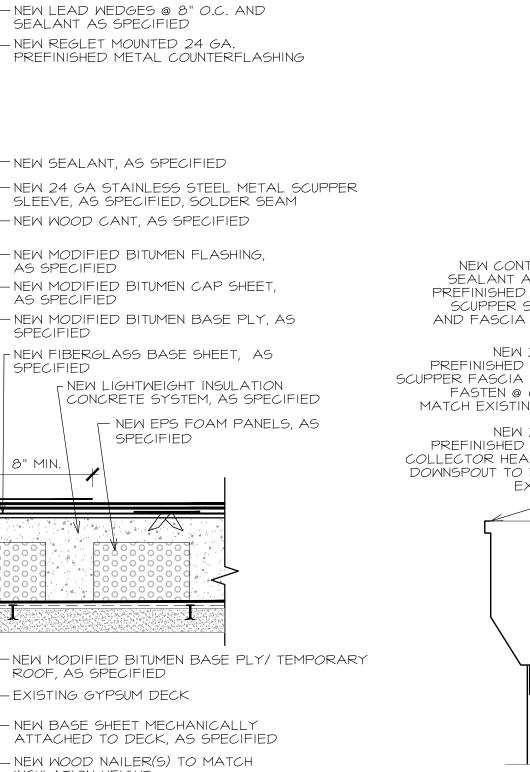

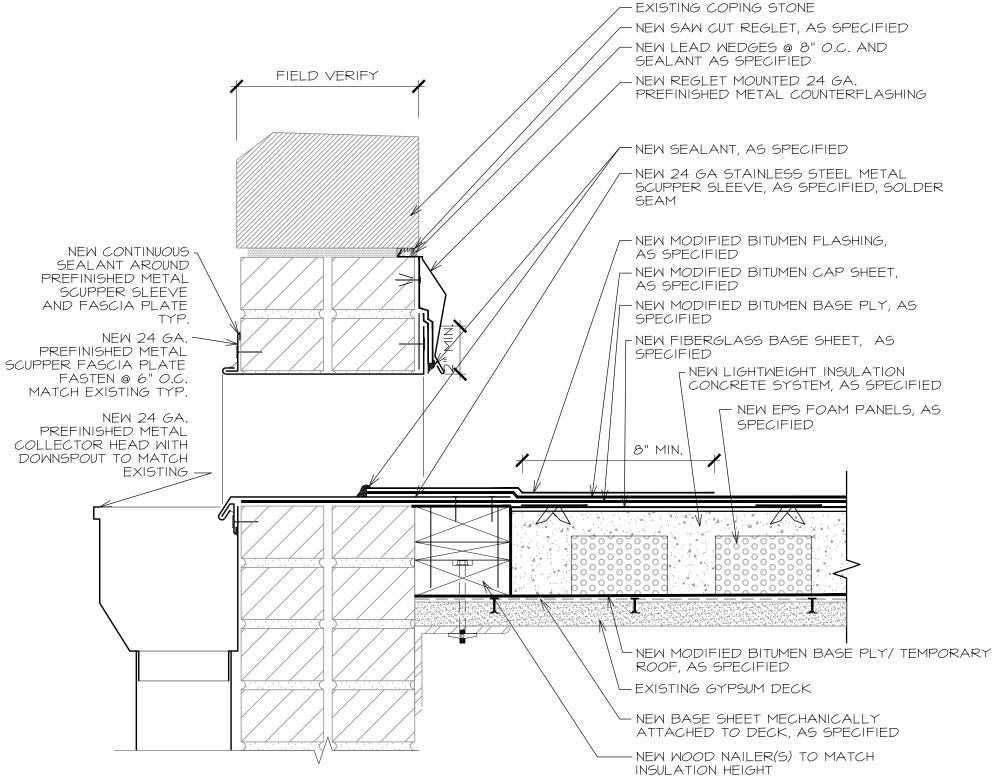

(26) THRU-WALL OVERFLOW SCUPPER (NEW) A-504 SCALE: 3" = 1'-0"

SCALE: 3" = 1'-0"



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COURTHOU

-NEW ONE WAY ROOF VENTS,

- NEW MODIFIED BITUMEN CAP


SHEET, AS SPECIFIED

-NEW MODIFIED BITUMEN


AS SPECIFIED

DESCRIPTION: 0 01/27/2017 ISSUE FOR BID SET PROJECT NO: 1-132-1 CAD DWG FILE: A-500 DETAILS DRAWN BY: CHECKED BY: OCCUPANCY GROUP: SHEET TITLE:

DETAILS

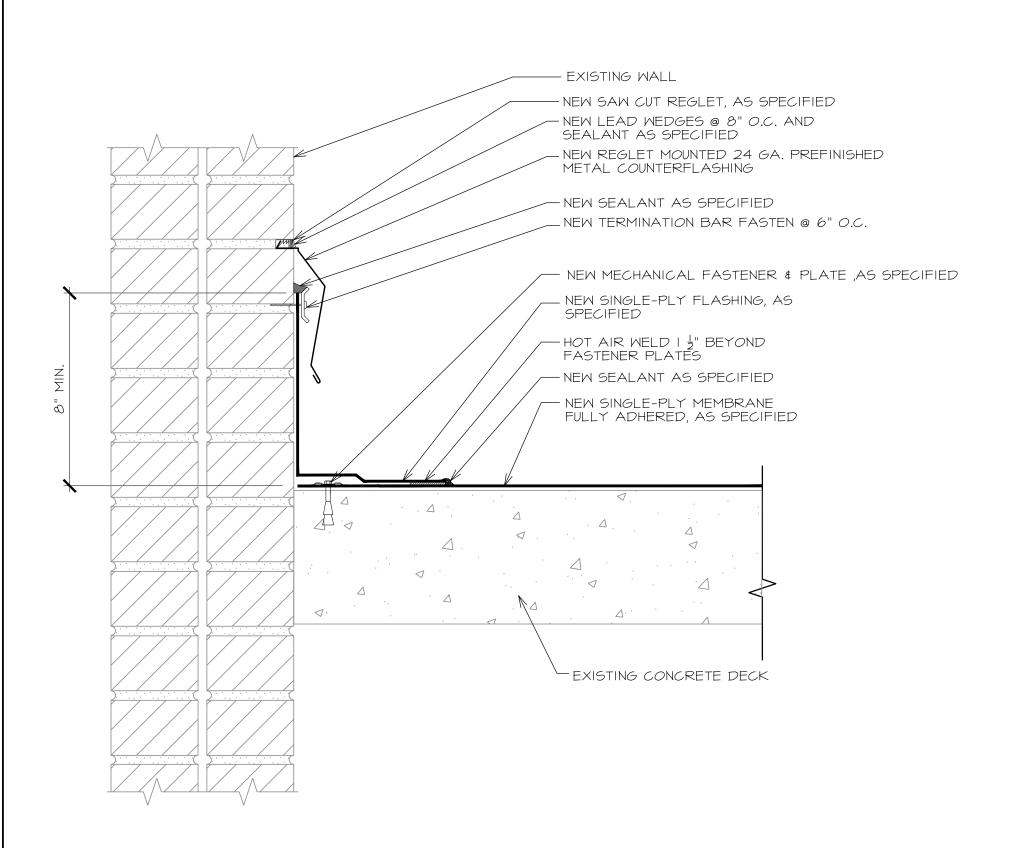

NEW SINGLE-PLY FLASHING, AS SPECIFIED — HOT AIR WELD I ½" BEYOND FASTENER PLATES MEW SEALANT, AS SPECIFIED HOT AIR WELD I & BEYOND - NEW SINGLE-PLY MEMBRANE FULLY FASTENÉR PLATES ADHERED, AS SPECIFIED NEW SEALANT, AS SPECIFIED -CONTINUOUS GALVANIZED -CLEAT FASTENED AT 8" O.C. NEW PVC COATED METAL EDGE — FASTENED AT 8" O.C. STAGGERED - EXISTING CONCRETE DECK

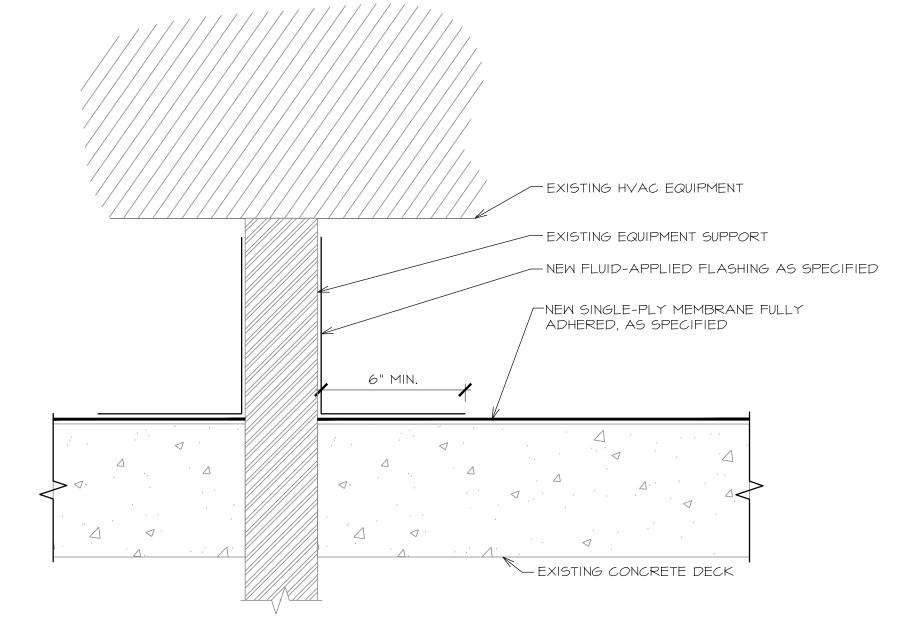



ISSUED FOR NOT FOR CONSTRUCTION THESE DOCUMENTS ARE FOR BIDDING PURPOSES ONLY. NOT TO BE USED FOR CONSTRUCTION.


A-505 SCALE: 3" = 1'-0"

A-505 SCALE: 3" = 1'-0"

EQUIPMENT SUPPORT A-505 SCALE: 3" = 1'-0"

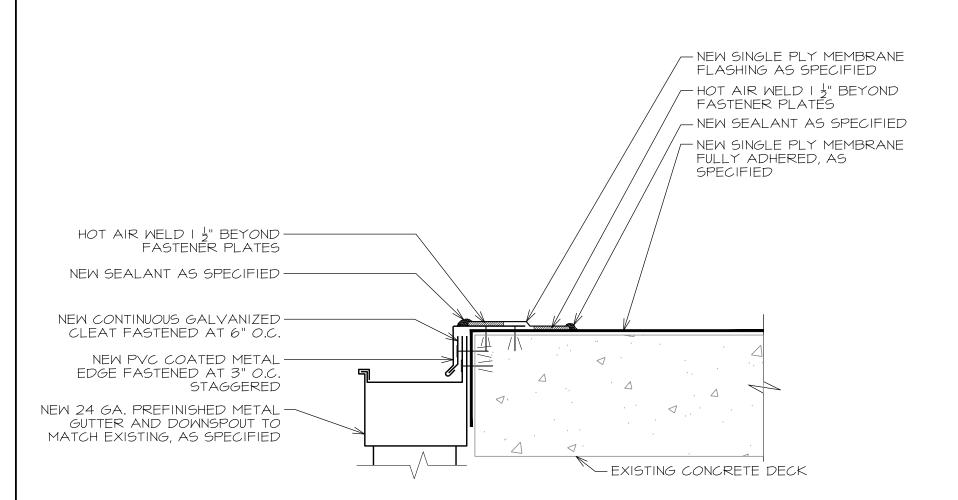

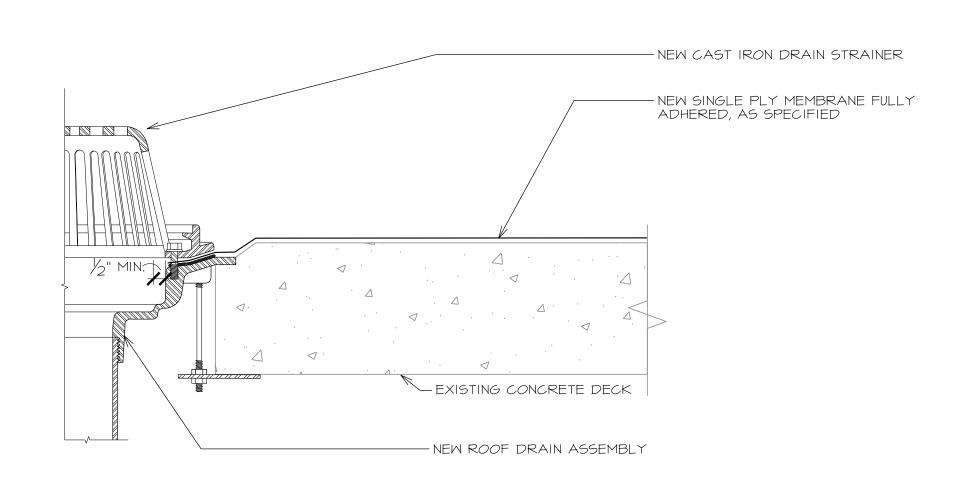

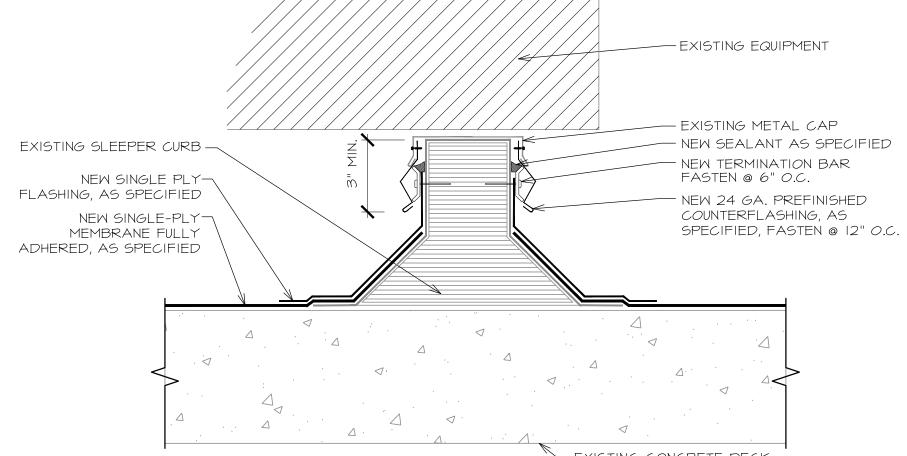

			W/	GUTTER
A-505	SCALE: 3" = 1	' <i>-0</i> "		





Consulting Group, LLC roof consulting & design DFW OFFICE 616 SOUTH COPPELL RD COPPELL, TX 75019 PHONE:214.758.0785 AMARILLO OFFICE 7120 I-40 WEST, SUITE 210 AMARILLO, TX 79106 PHONE: 806.356.6059

PROJE COURTHOUS DESCRIPTION:


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DETAILS




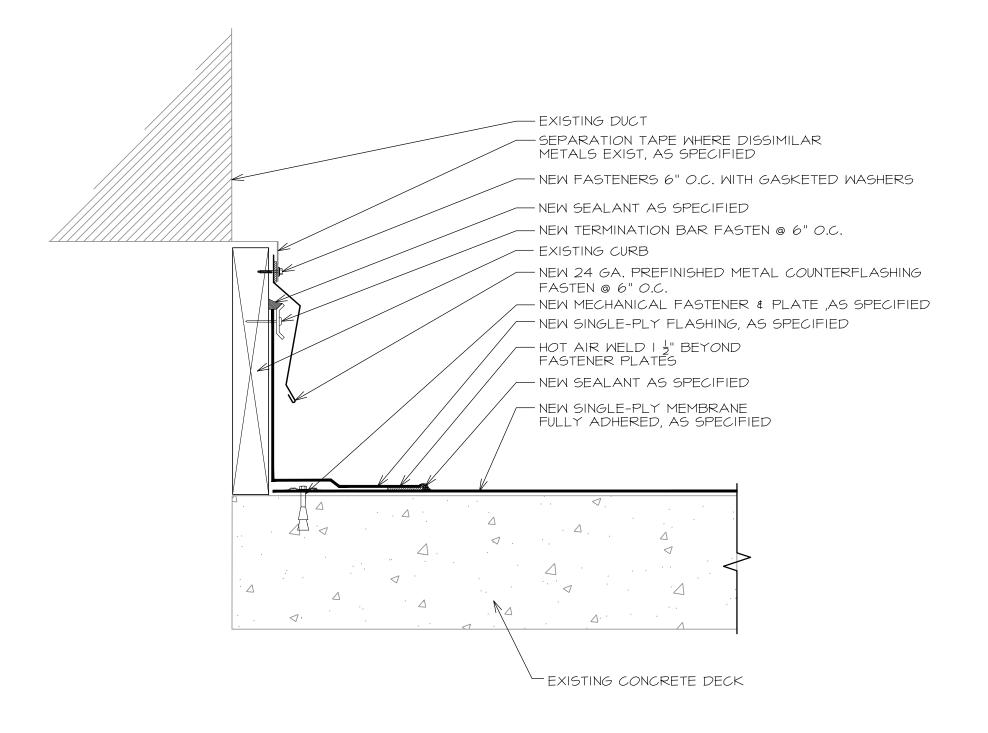

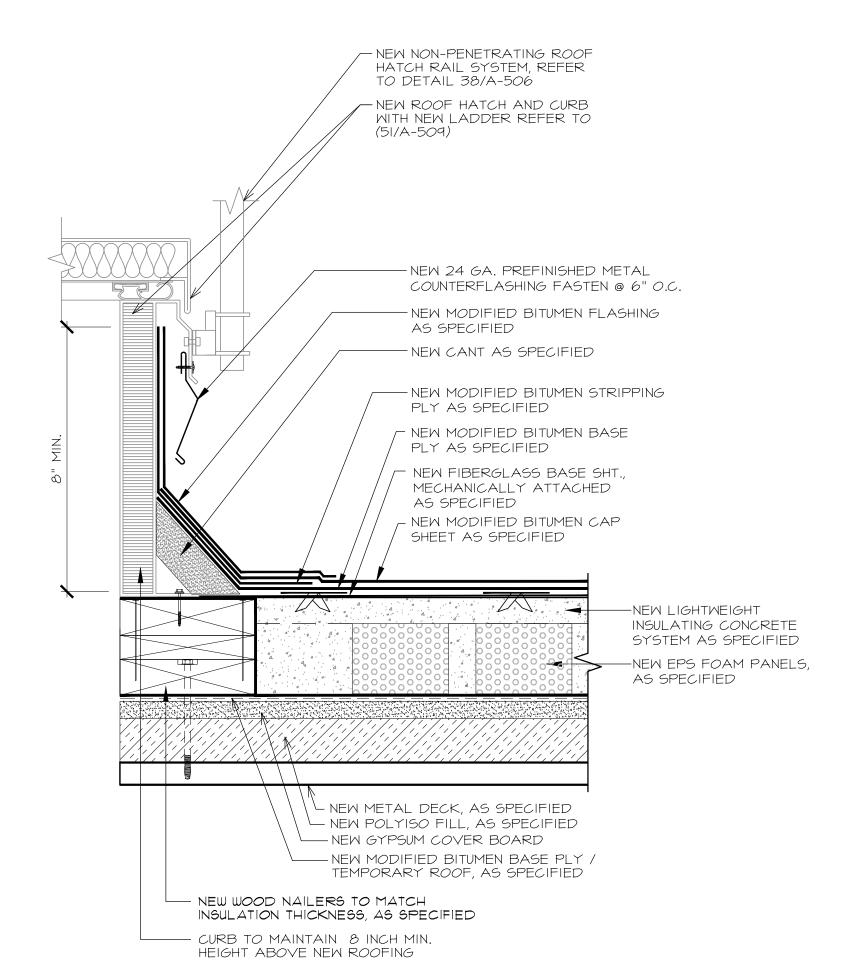


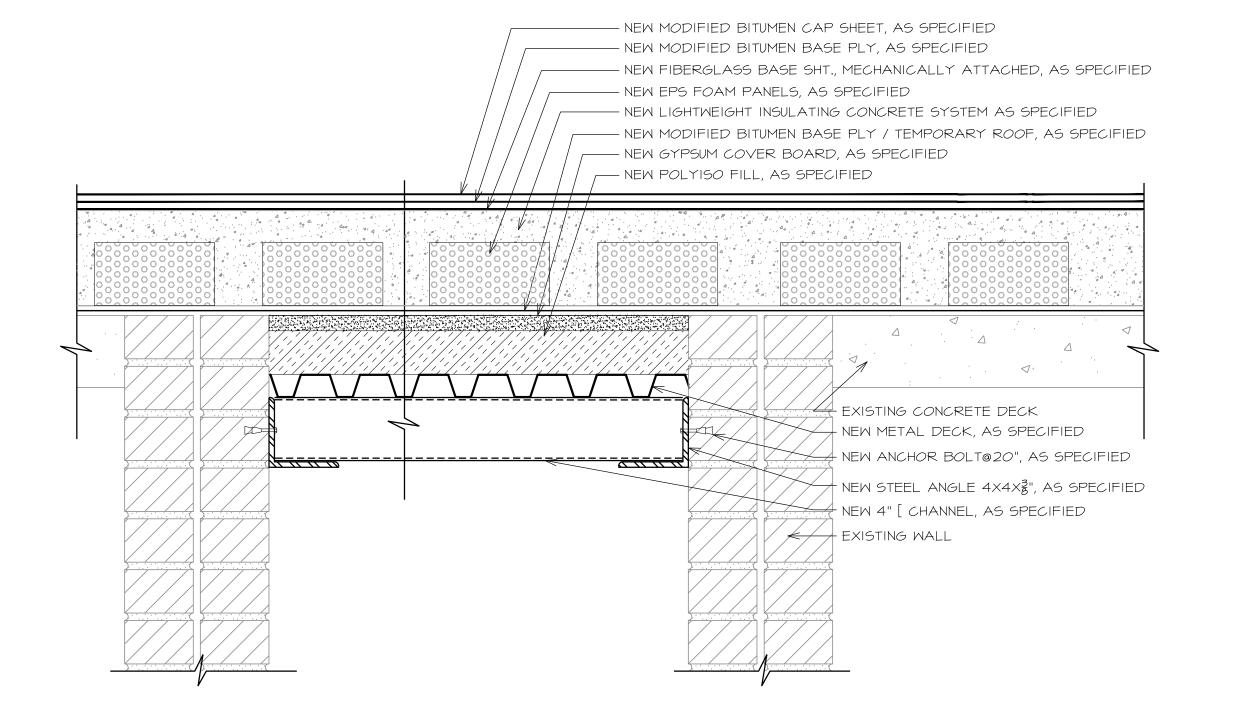

OPENING CLOSURE DETAIL

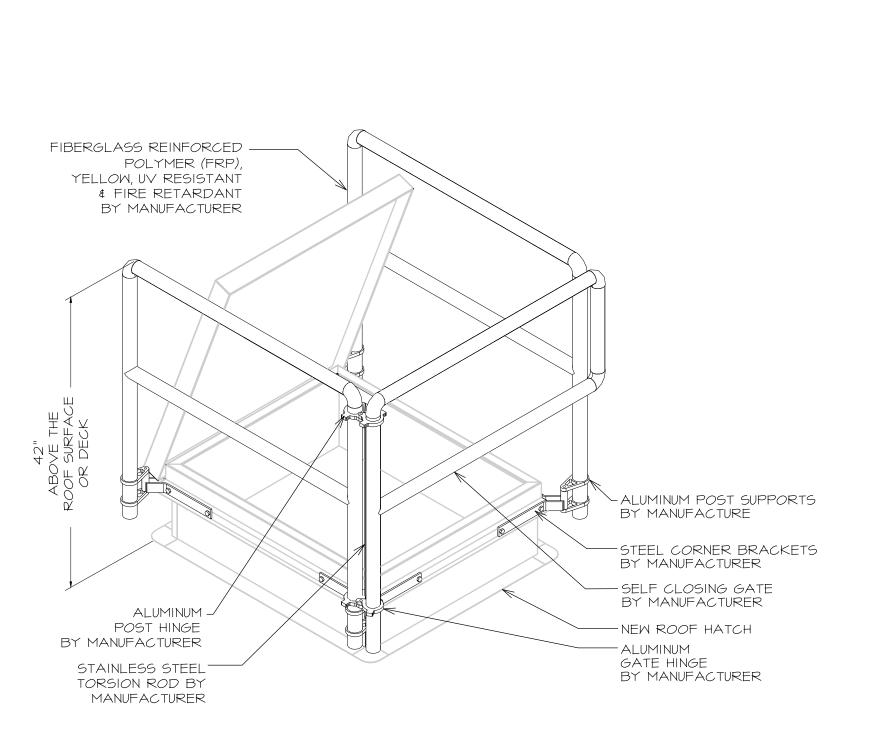



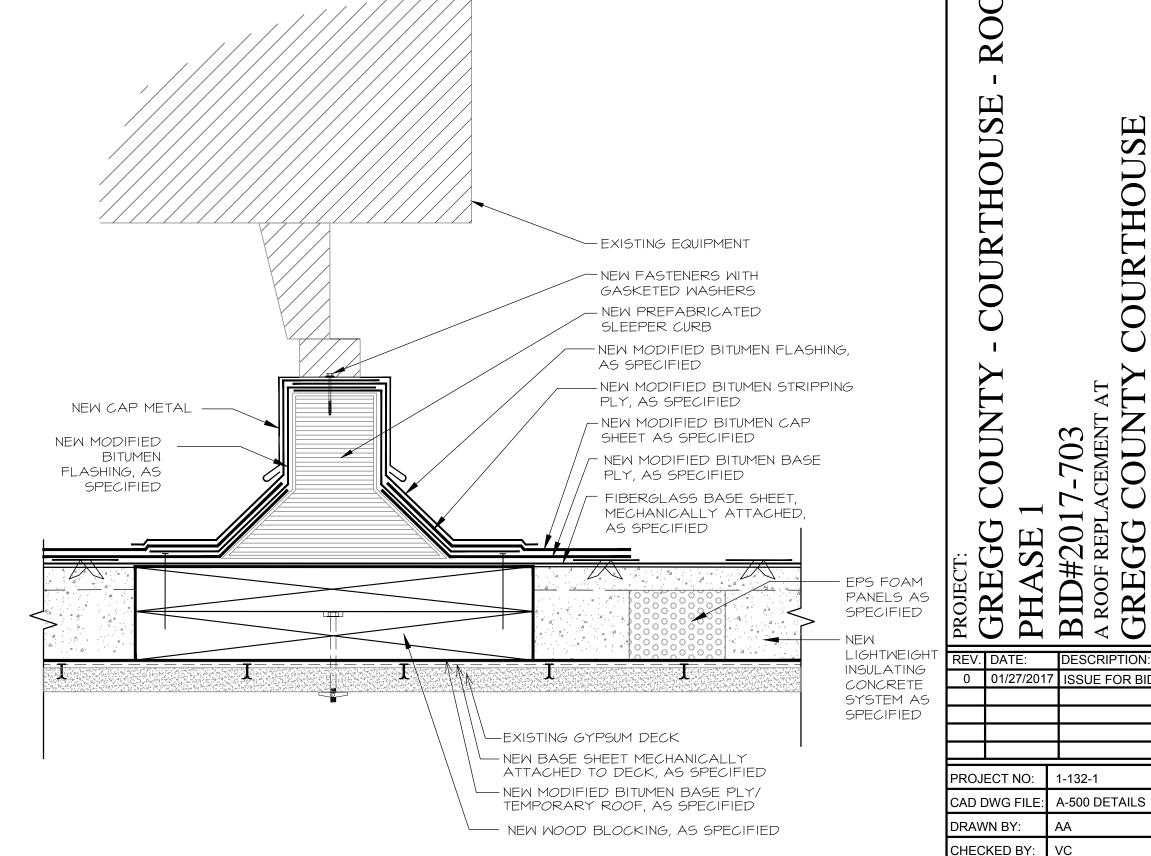

EQUIPMENT ON PREFABRICATED CURB A-506 SCALE: 3" = 1'-0"

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ISSUED FOR


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PROJE COURTHOU DESCRIPTION: 0 01/27/2017 ISSUE FOR BID SET


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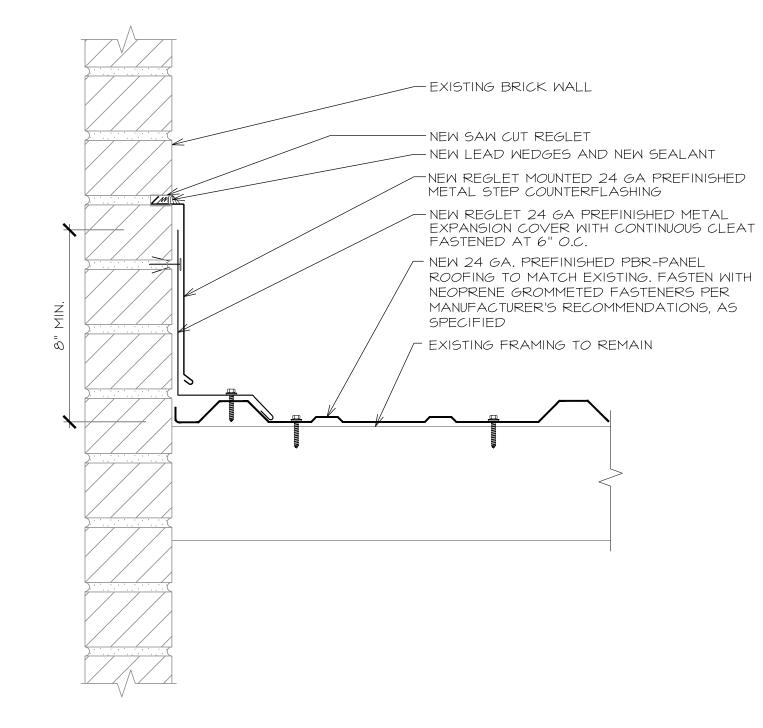
DETAILS

1-132-1





SCALE: 3" = 1'-0"

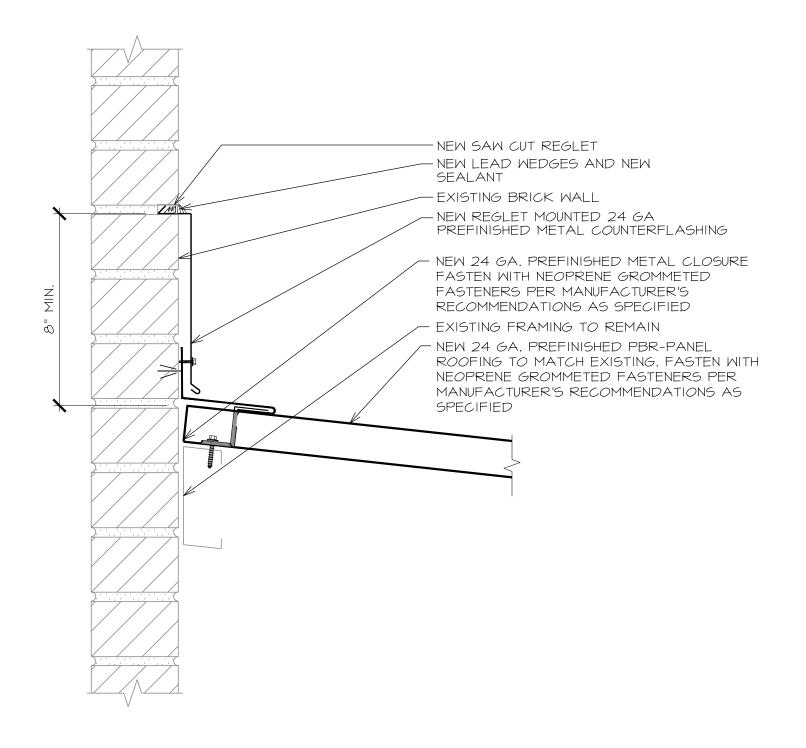

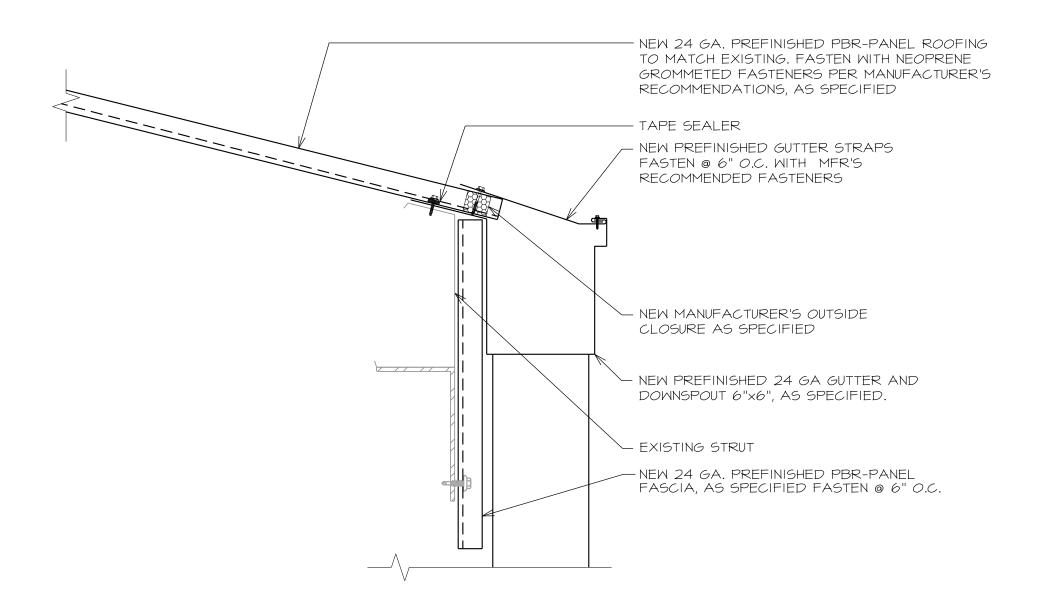





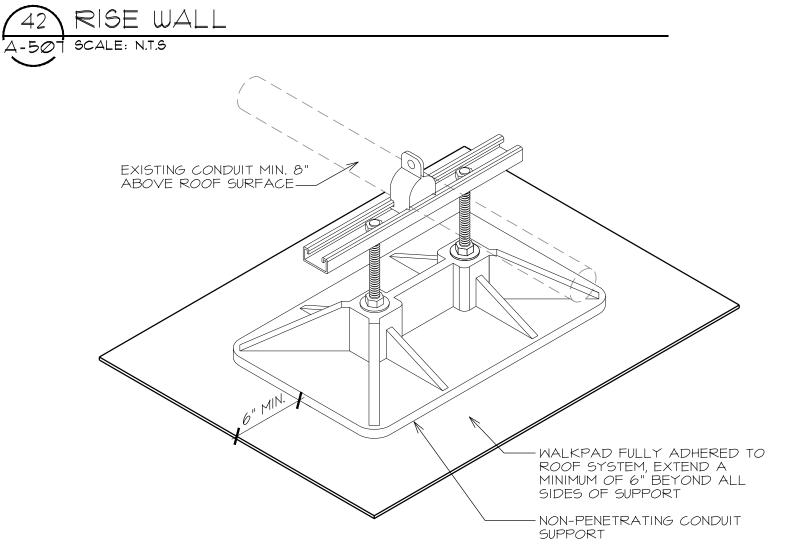

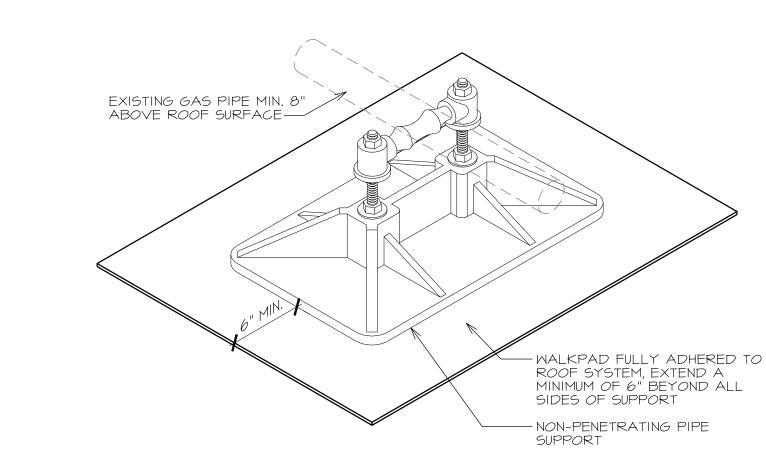

45 NON PENETRATING PIPE & CONDUIT SUPPORT A-501 SCALE: 3" = 1'-0"

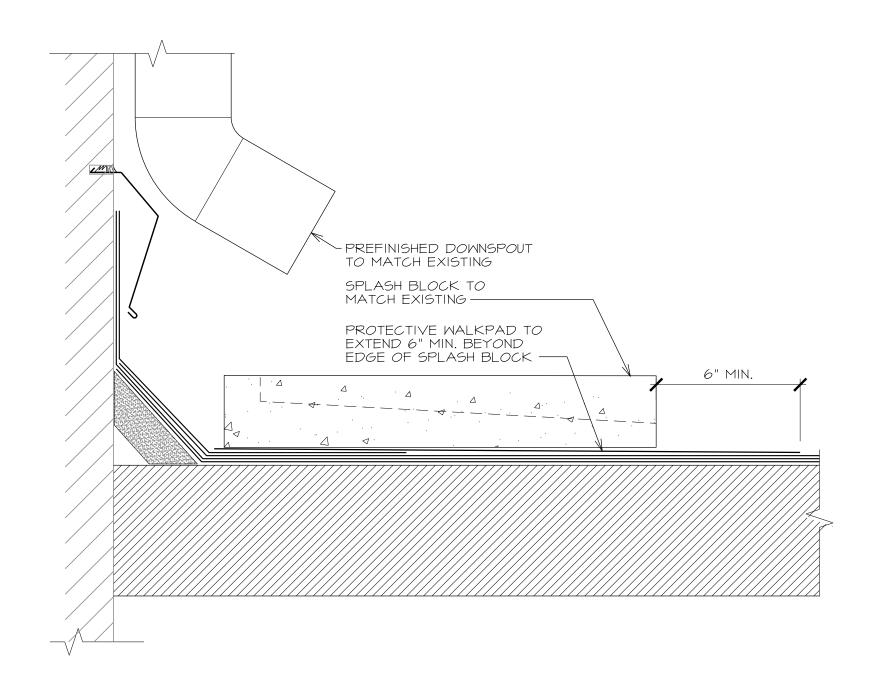

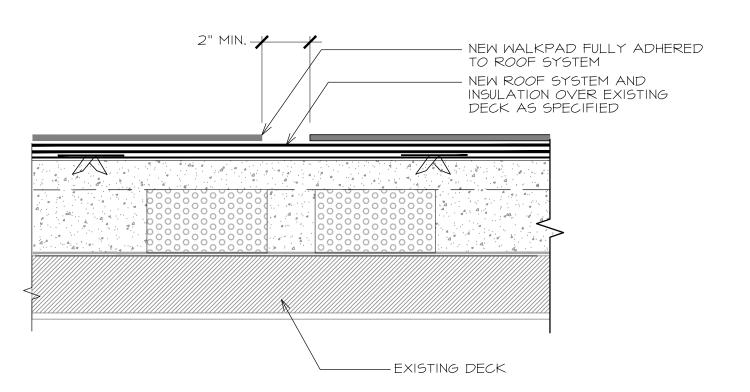





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EGG COUNTY - COURTHOUSE - ROOFING PROJECT SE 1
#2017-703
#REPLACEMENT AT


COURTHOUSE

PROJECT NO: 1-132-1
CAD DWG FILE: A-500 DETAILS
DRAWN BY: AA
CHECKED BY: VC
OCCUPANCY
GROUP: GROUP A

SHEET TITLE:
DETAILS

Δ_**5**Ω




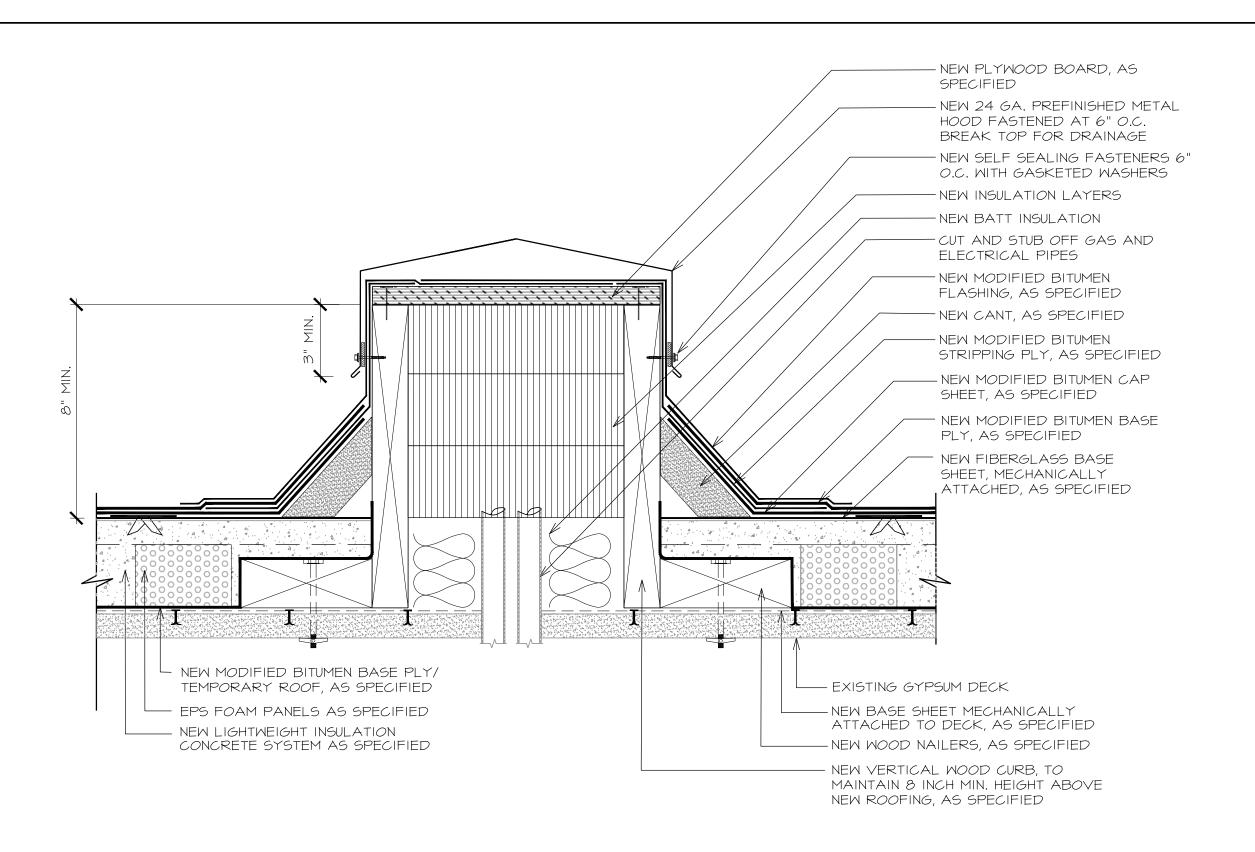

NEW METAL CAP OVER EXISTING SUPPLY LINES A-508 SCALE: 3" = 1'-0"


NOTE:


ROUTE PIPING WITH POSITIVE SLOPE UNDER WINDOWS AND BEYOND EXTERIOR WALL.

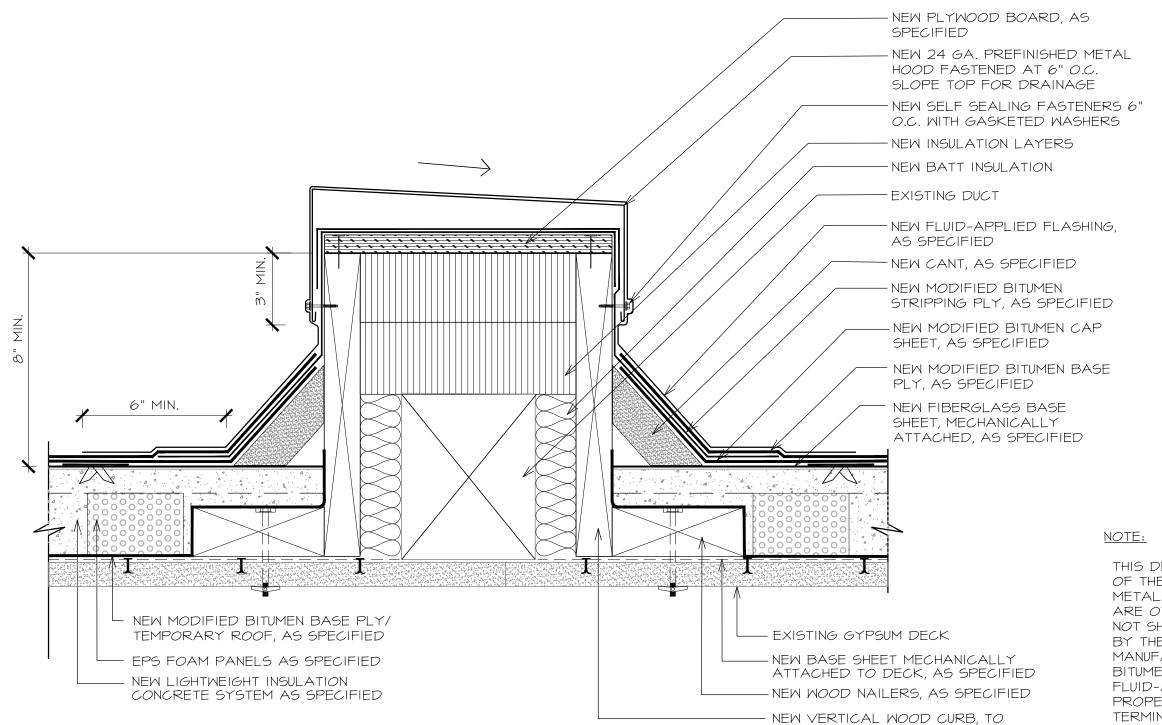


THIS DETAIL SHOWS A CROSS-SECTION OF THE CLOSURE FOR THE HVAC UNIT METALWORK ON AREA N-2.° THERE ARE OTHER SURFACES AND ANGLES NOT SHOWN THAT WILL BE ADDRESSED BY THE CONTRACTOR, A/E AND MANUFACTURER OF THE MODIFIED BITUMEN MEMBRANES AND FLUID-APPLIED FLASHING MATERIALS. PROPER FLASHING INSTALLATION AND TERMINATIONS WILL BE DETERMINED IN A CONFIGURATION ELIGIBLE FOR THE SPECIFIED GUARANTEE.

NEW METAL CAP OVER EXISTING DUCT A-508 SCALE: 3" = 1'-0"

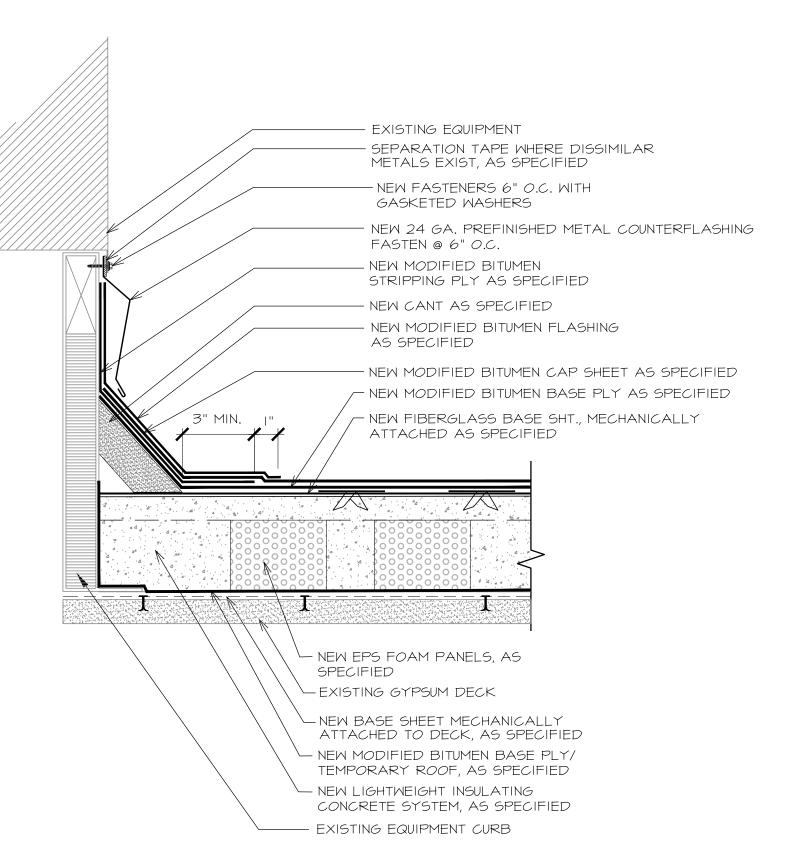

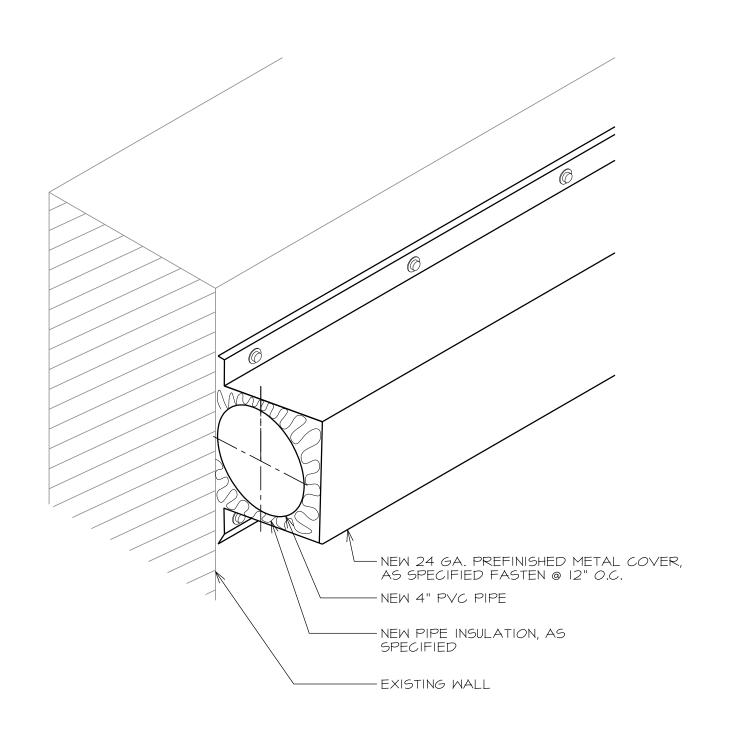

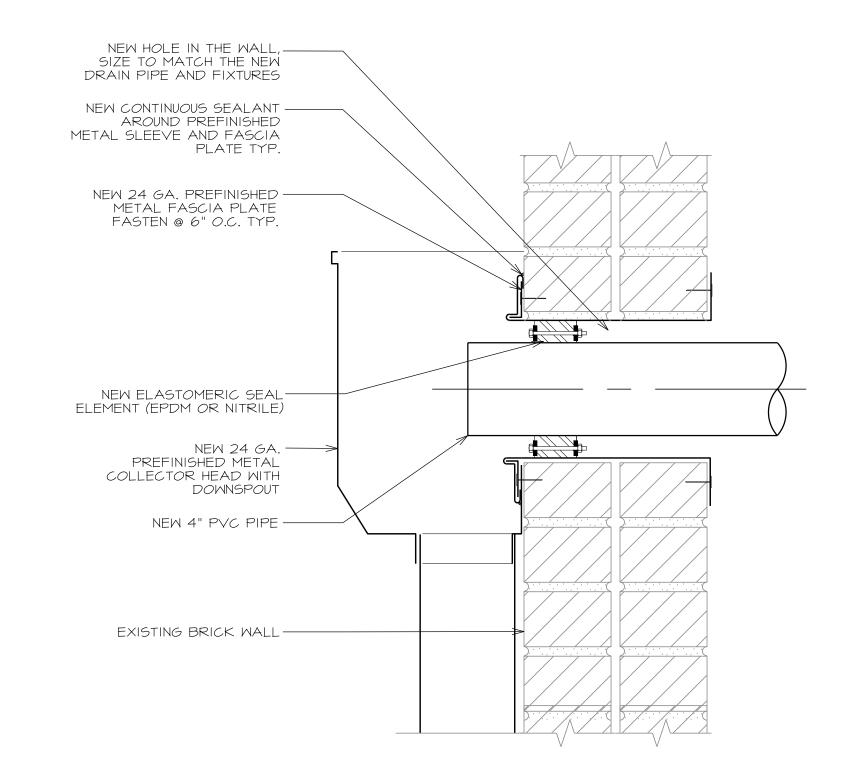

MAINTAIN 8 INCH MIN. HEIGHT ABOVE

NEW ROOFING, AS SPECIFIED





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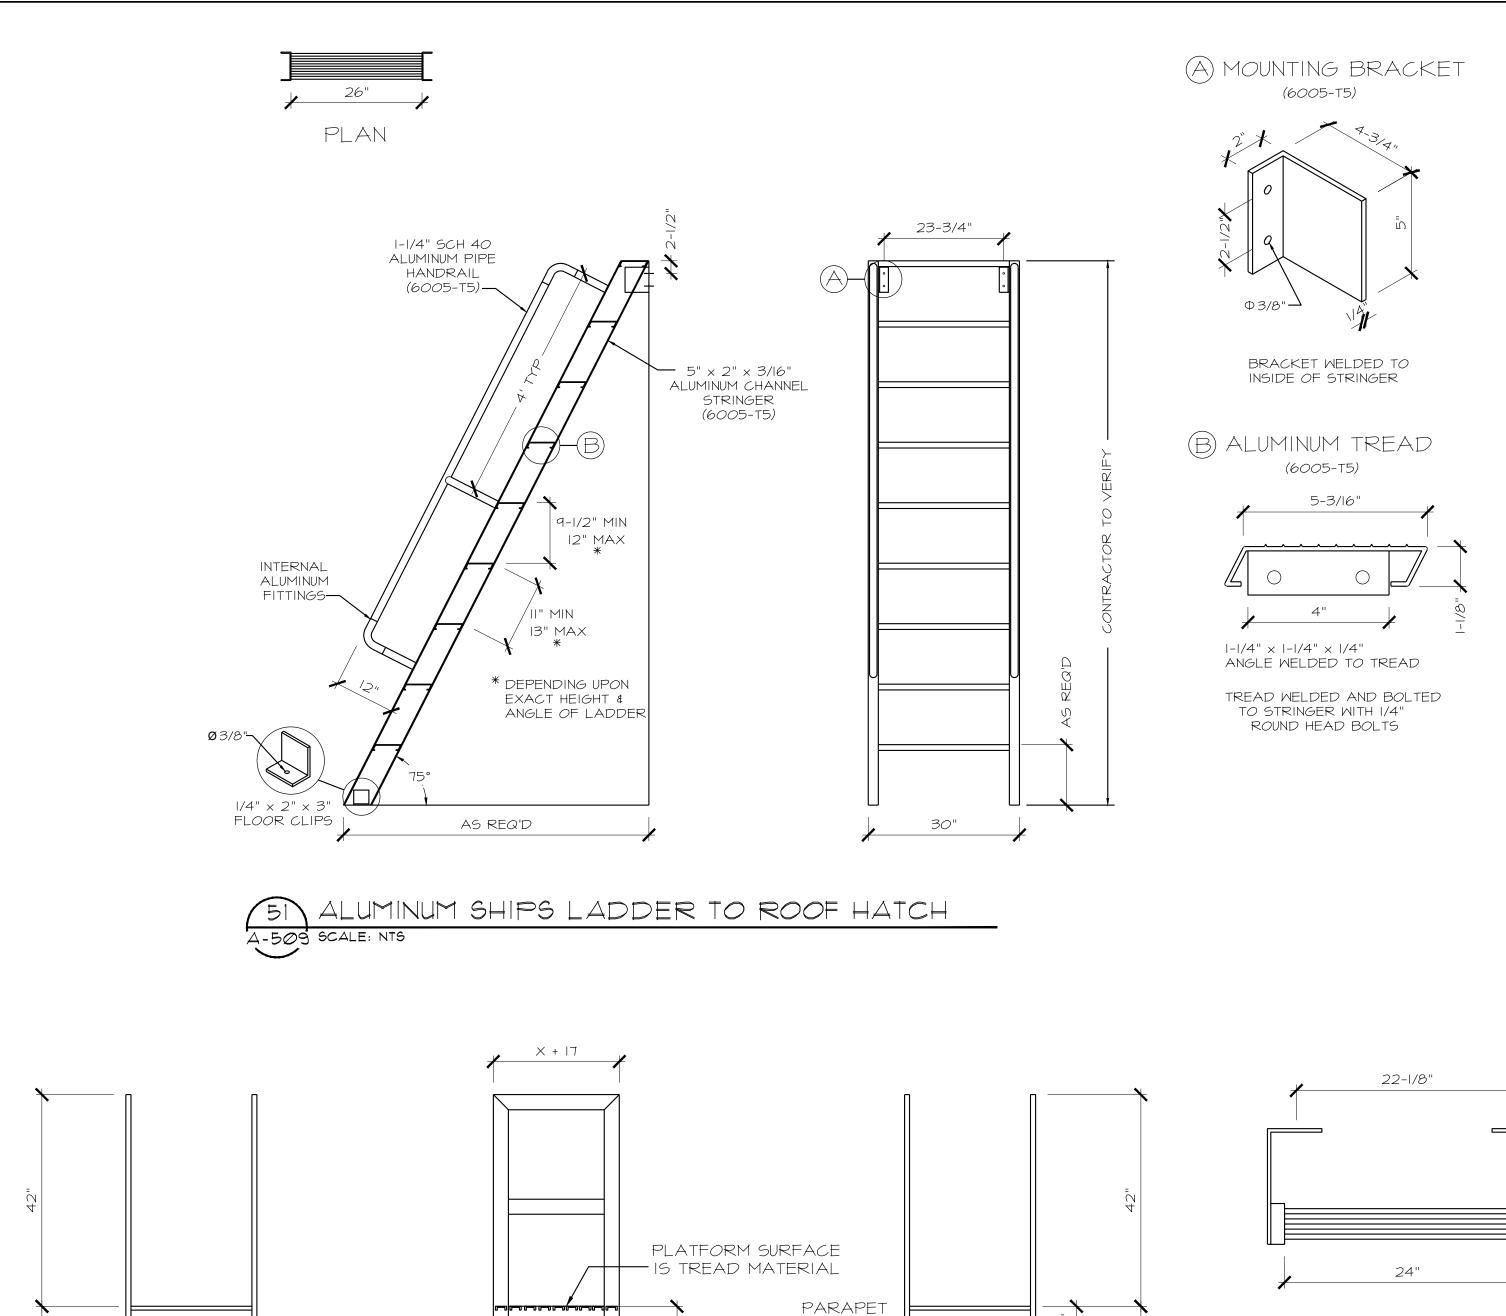
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DESCRIPTION: 0 01/27/2017 ISSUE FOR BID SET PROJECT NO: 1-132-1 CAD DWG FILE: A-500 DETAILS DRAWN BY: CHECKED BY: OCCUPANCY

SHEET TITLE: DETAILS

GROUP:




LEVEL


3" × 1" × 1/8" ALUMINUM TUBULAR SIDERAIL — (6005-T5)


2-1/4" SERRATED ALUMINUM TREAD (6005-T5)——


COMPLY WITH OSHA 1910.27 AND ANSI 14.3

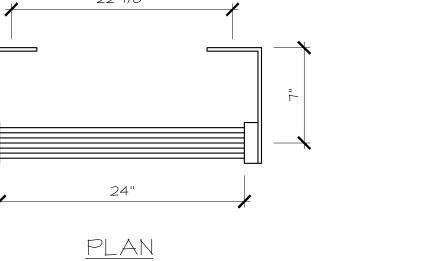

(PARAPET PLATFORM & RETURN LADDER ARE OMITTED FOR CLARITY)

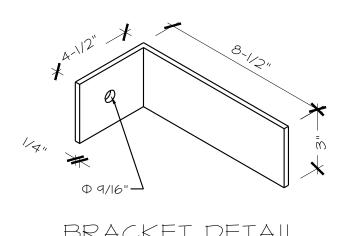

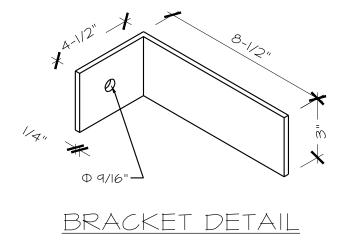

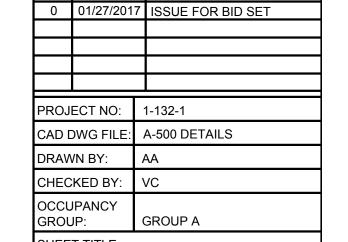

COURTHOUSE

Consulting Group, LLC

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COPPELL, TX 75019

PHONE:214.758.0785

AMARILLO OFFICE

7120 I-40 WEST, SUITE 210

AMARILLO, TX 79106 PHONE: 806.356.6059

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PROJECT


roof consulting & design

SHEET TITLE:

52 FIXED ROOF LADDER A-509 SCALE: NTS

CONTRACTOR TO VERIFY

26"

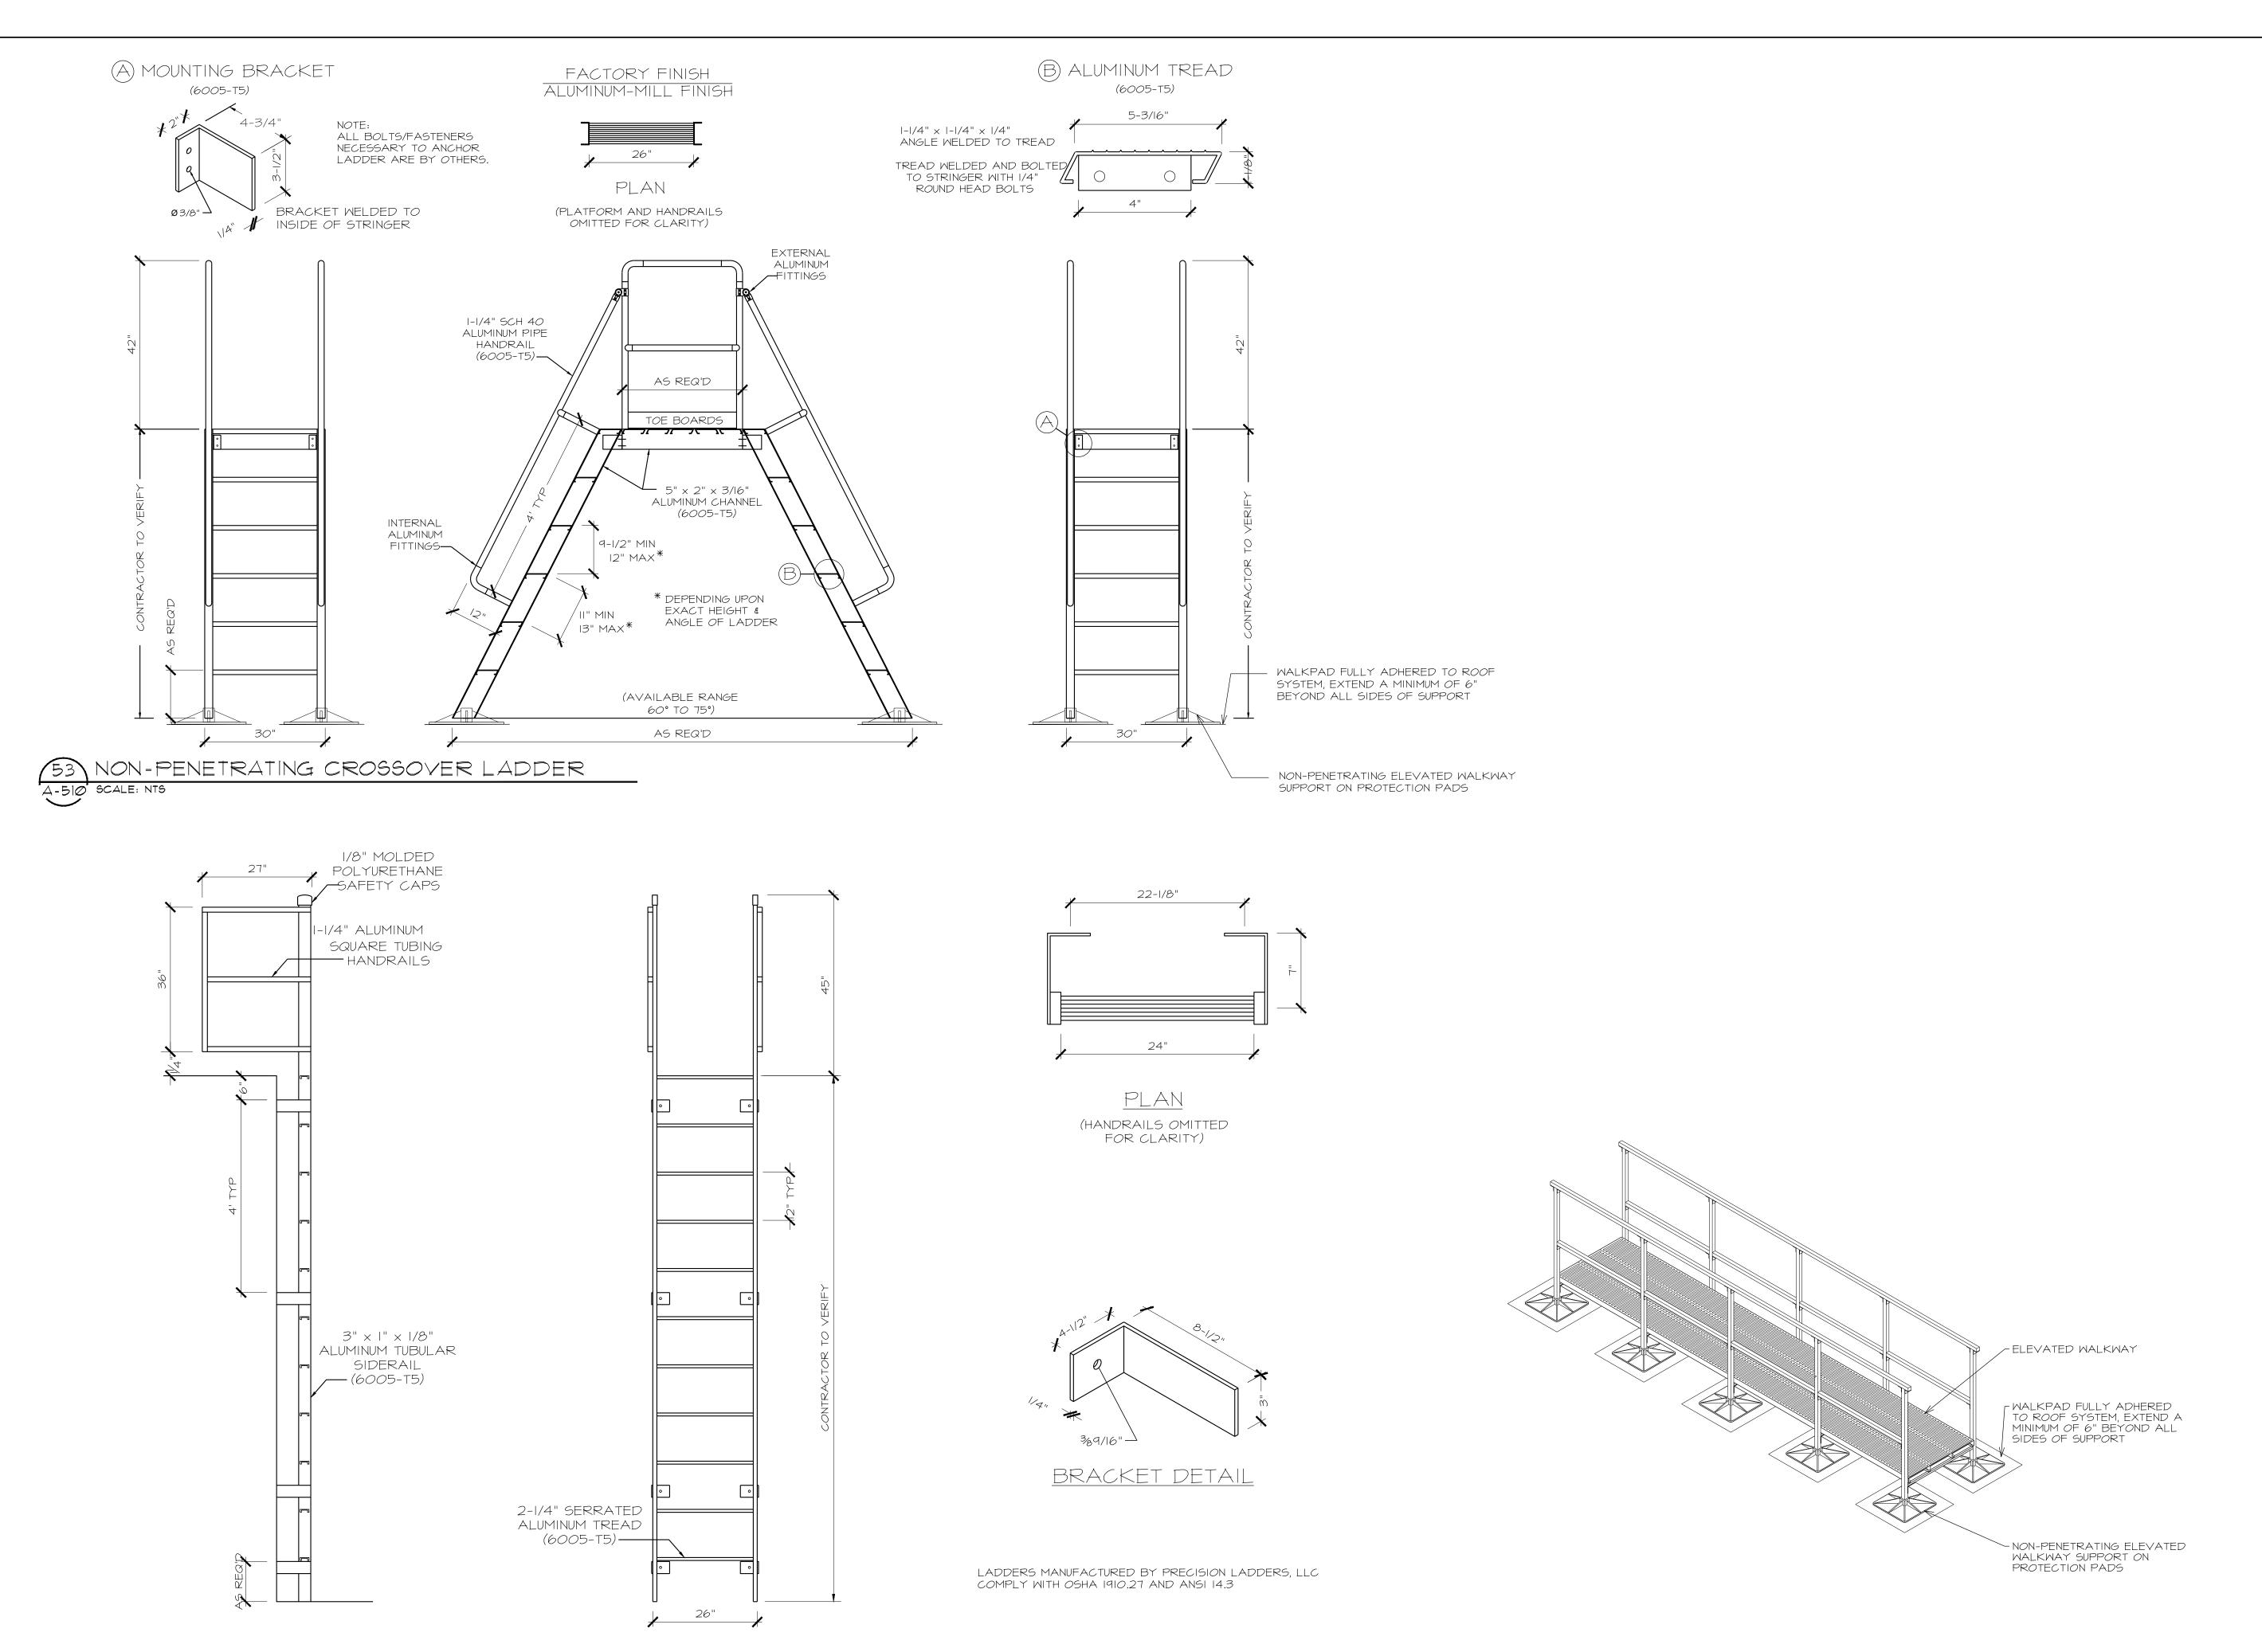

54 FIXED LADDER W/WALK-THRU

A-510 SCALE: NTS

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PROJECT COURTHOUSE


0 01/27/2017 ISSUE FOR BID SET PROJECT NO: CAD DWG FILE: A-500 DETAILS DRAWN BY: CHECKED BY: OCCUPANCY GROUP:


SHEET TITLE: DETAILS

55 NON-PENETRATING ELEVATED WALKWAY

A-510 SCALE: NTS.

A-510

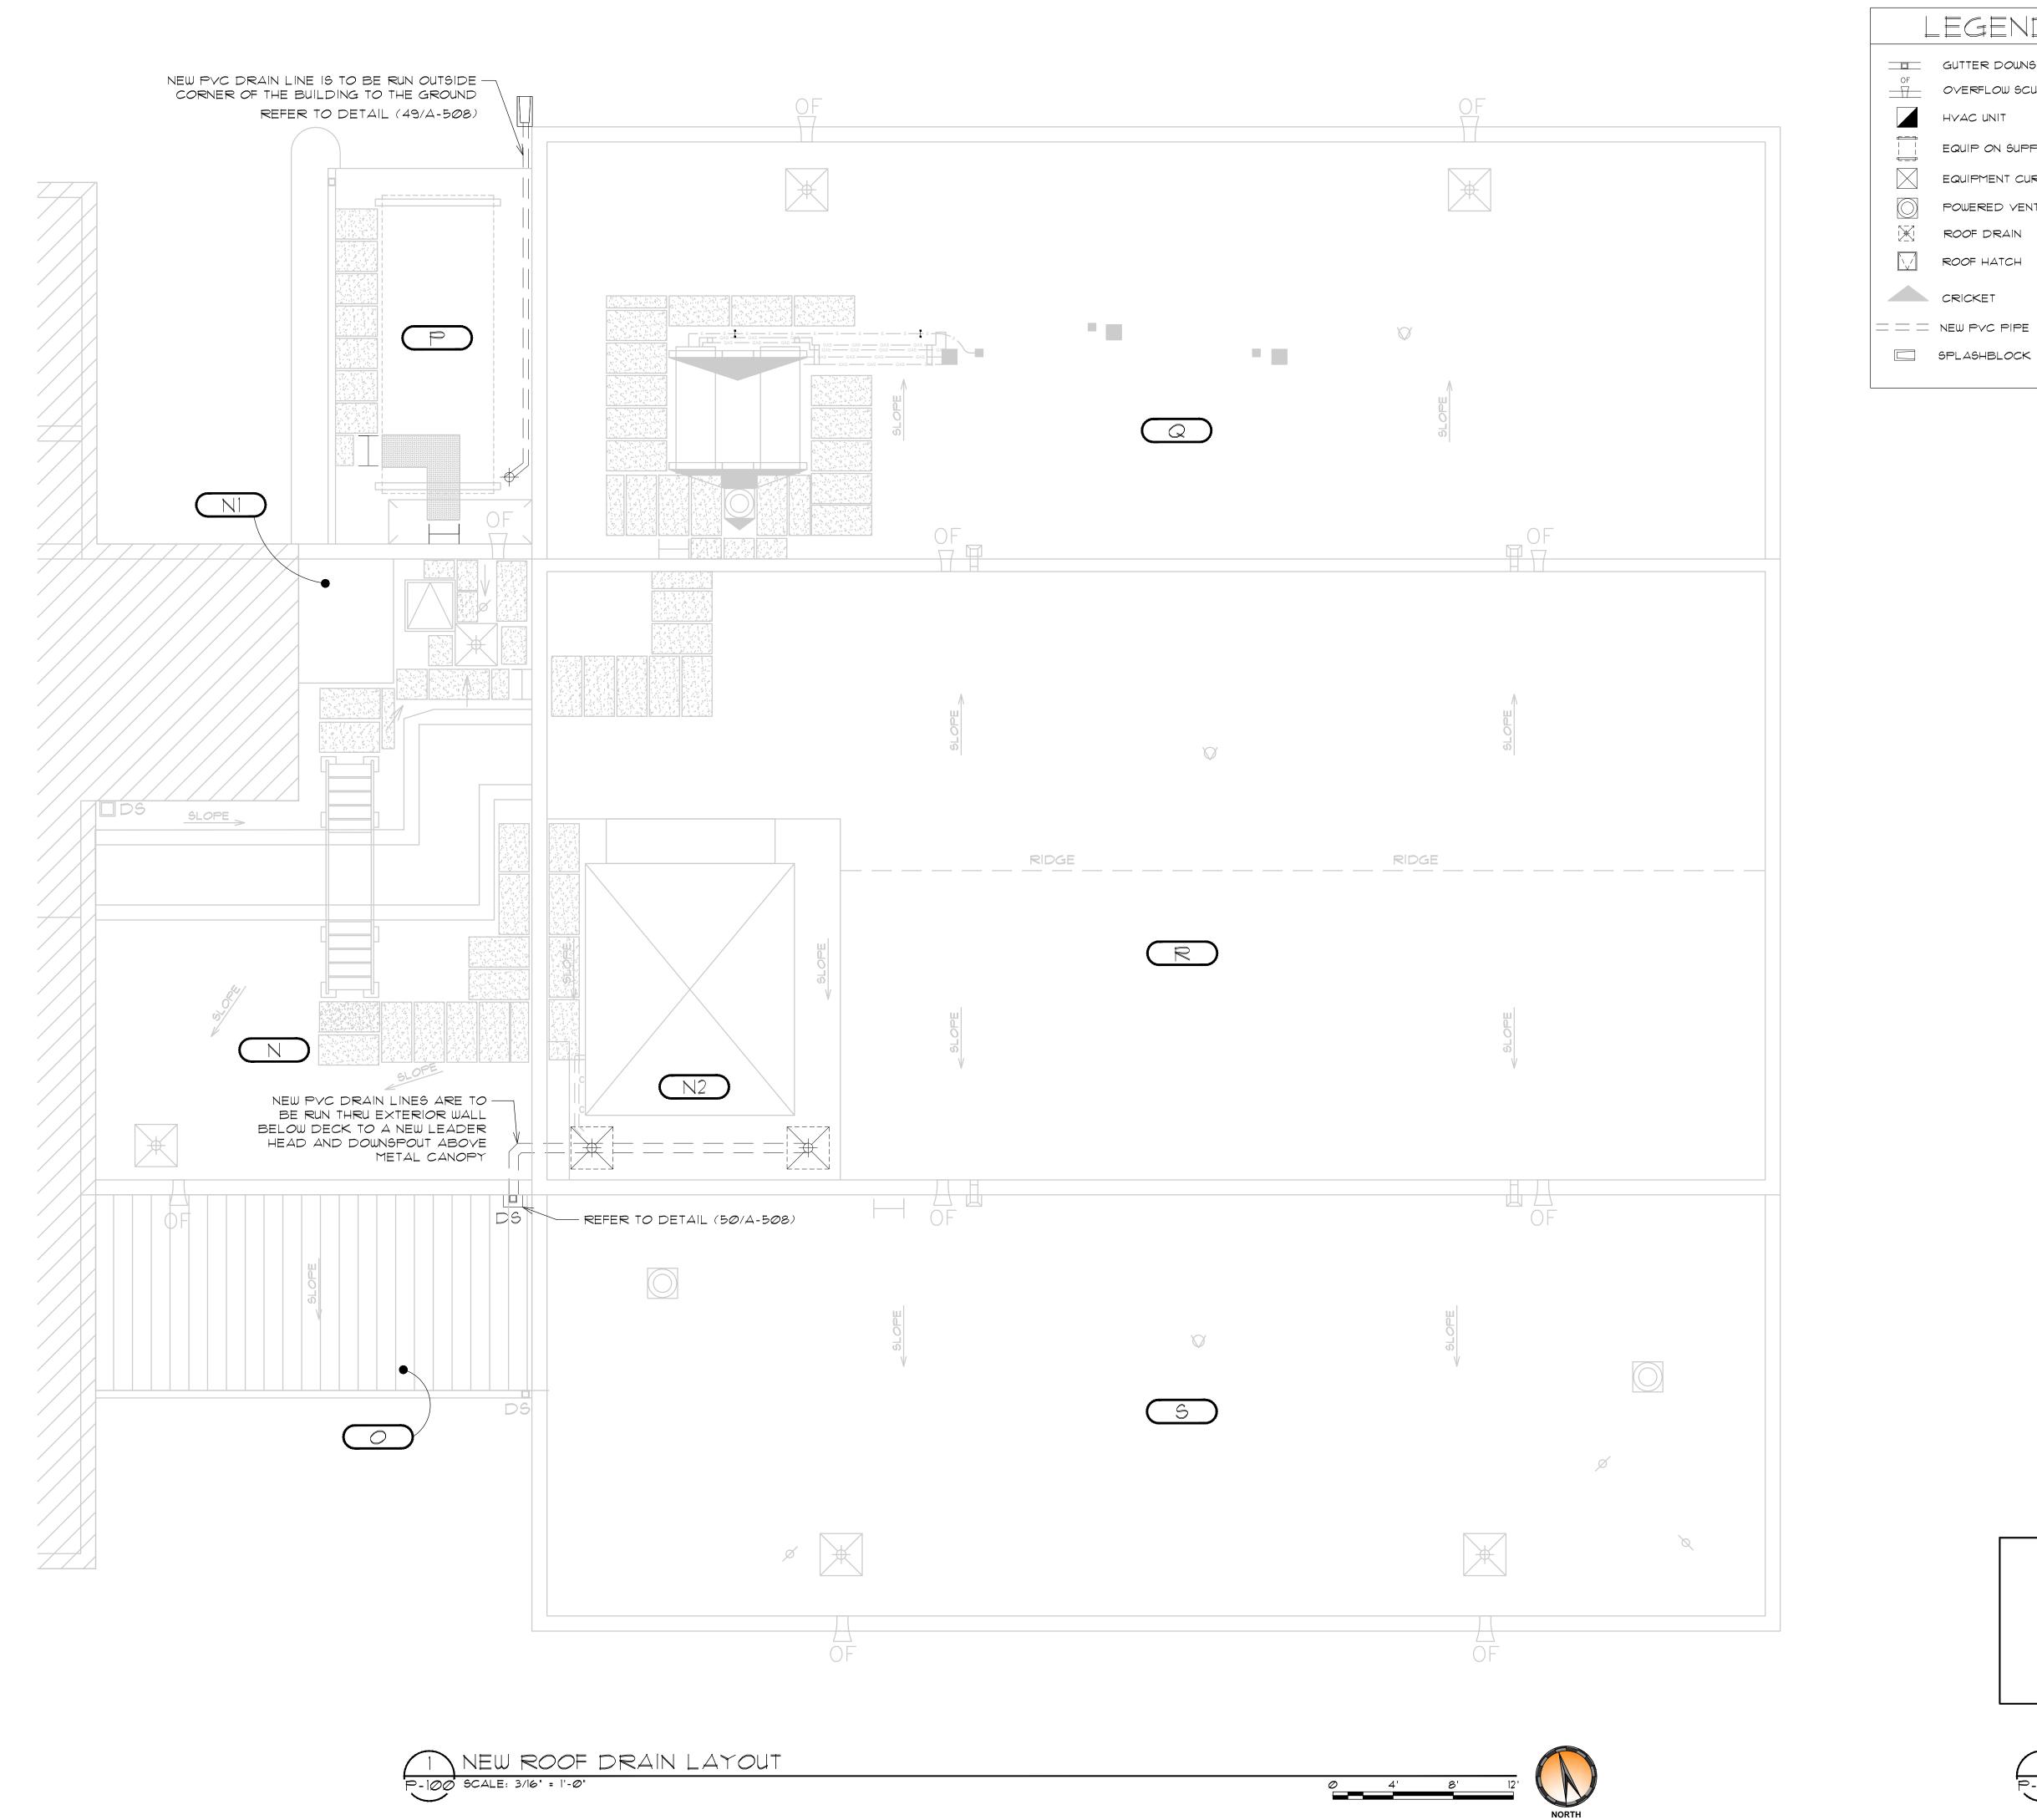

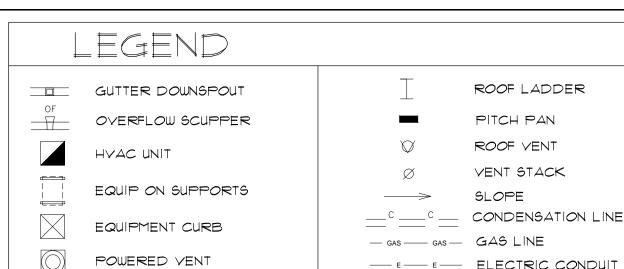

ROOF DRAIN

ROOF HATCH

- E-ELECTRIC CONDUIT GAS GAS PIPE SUPPORT WALK PAD ROOF AREA - ID NOT IN CONTRACT

DETAIL TAG DETAIL NUMBER DETAIL SHEET #

AMARILLO OFFICE 7120 I-40 WEST, SUITE 210 AMARILLO, TX 79106 PHONE: 806.356.6059 **ISSUED**

PROJEC

FOR

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roof consulting & design

THESE DOCUMENTS ARE FOR BIDDING PURPOSES ONLY. NOT TO BE USED FOR CONSTRUCTION.

NOT FOR CONSTRUCTION

0 01/27/2017 ISSUE FOR BID SET CAD DWG FILE: P100-Roof Drain Layout DRAWN BY: CHECKED BY: OCCUPANCY GROUP: SHEET TITLE:

COURTHOUSE

ROOF DRAIN LAYOUT

P-100

